
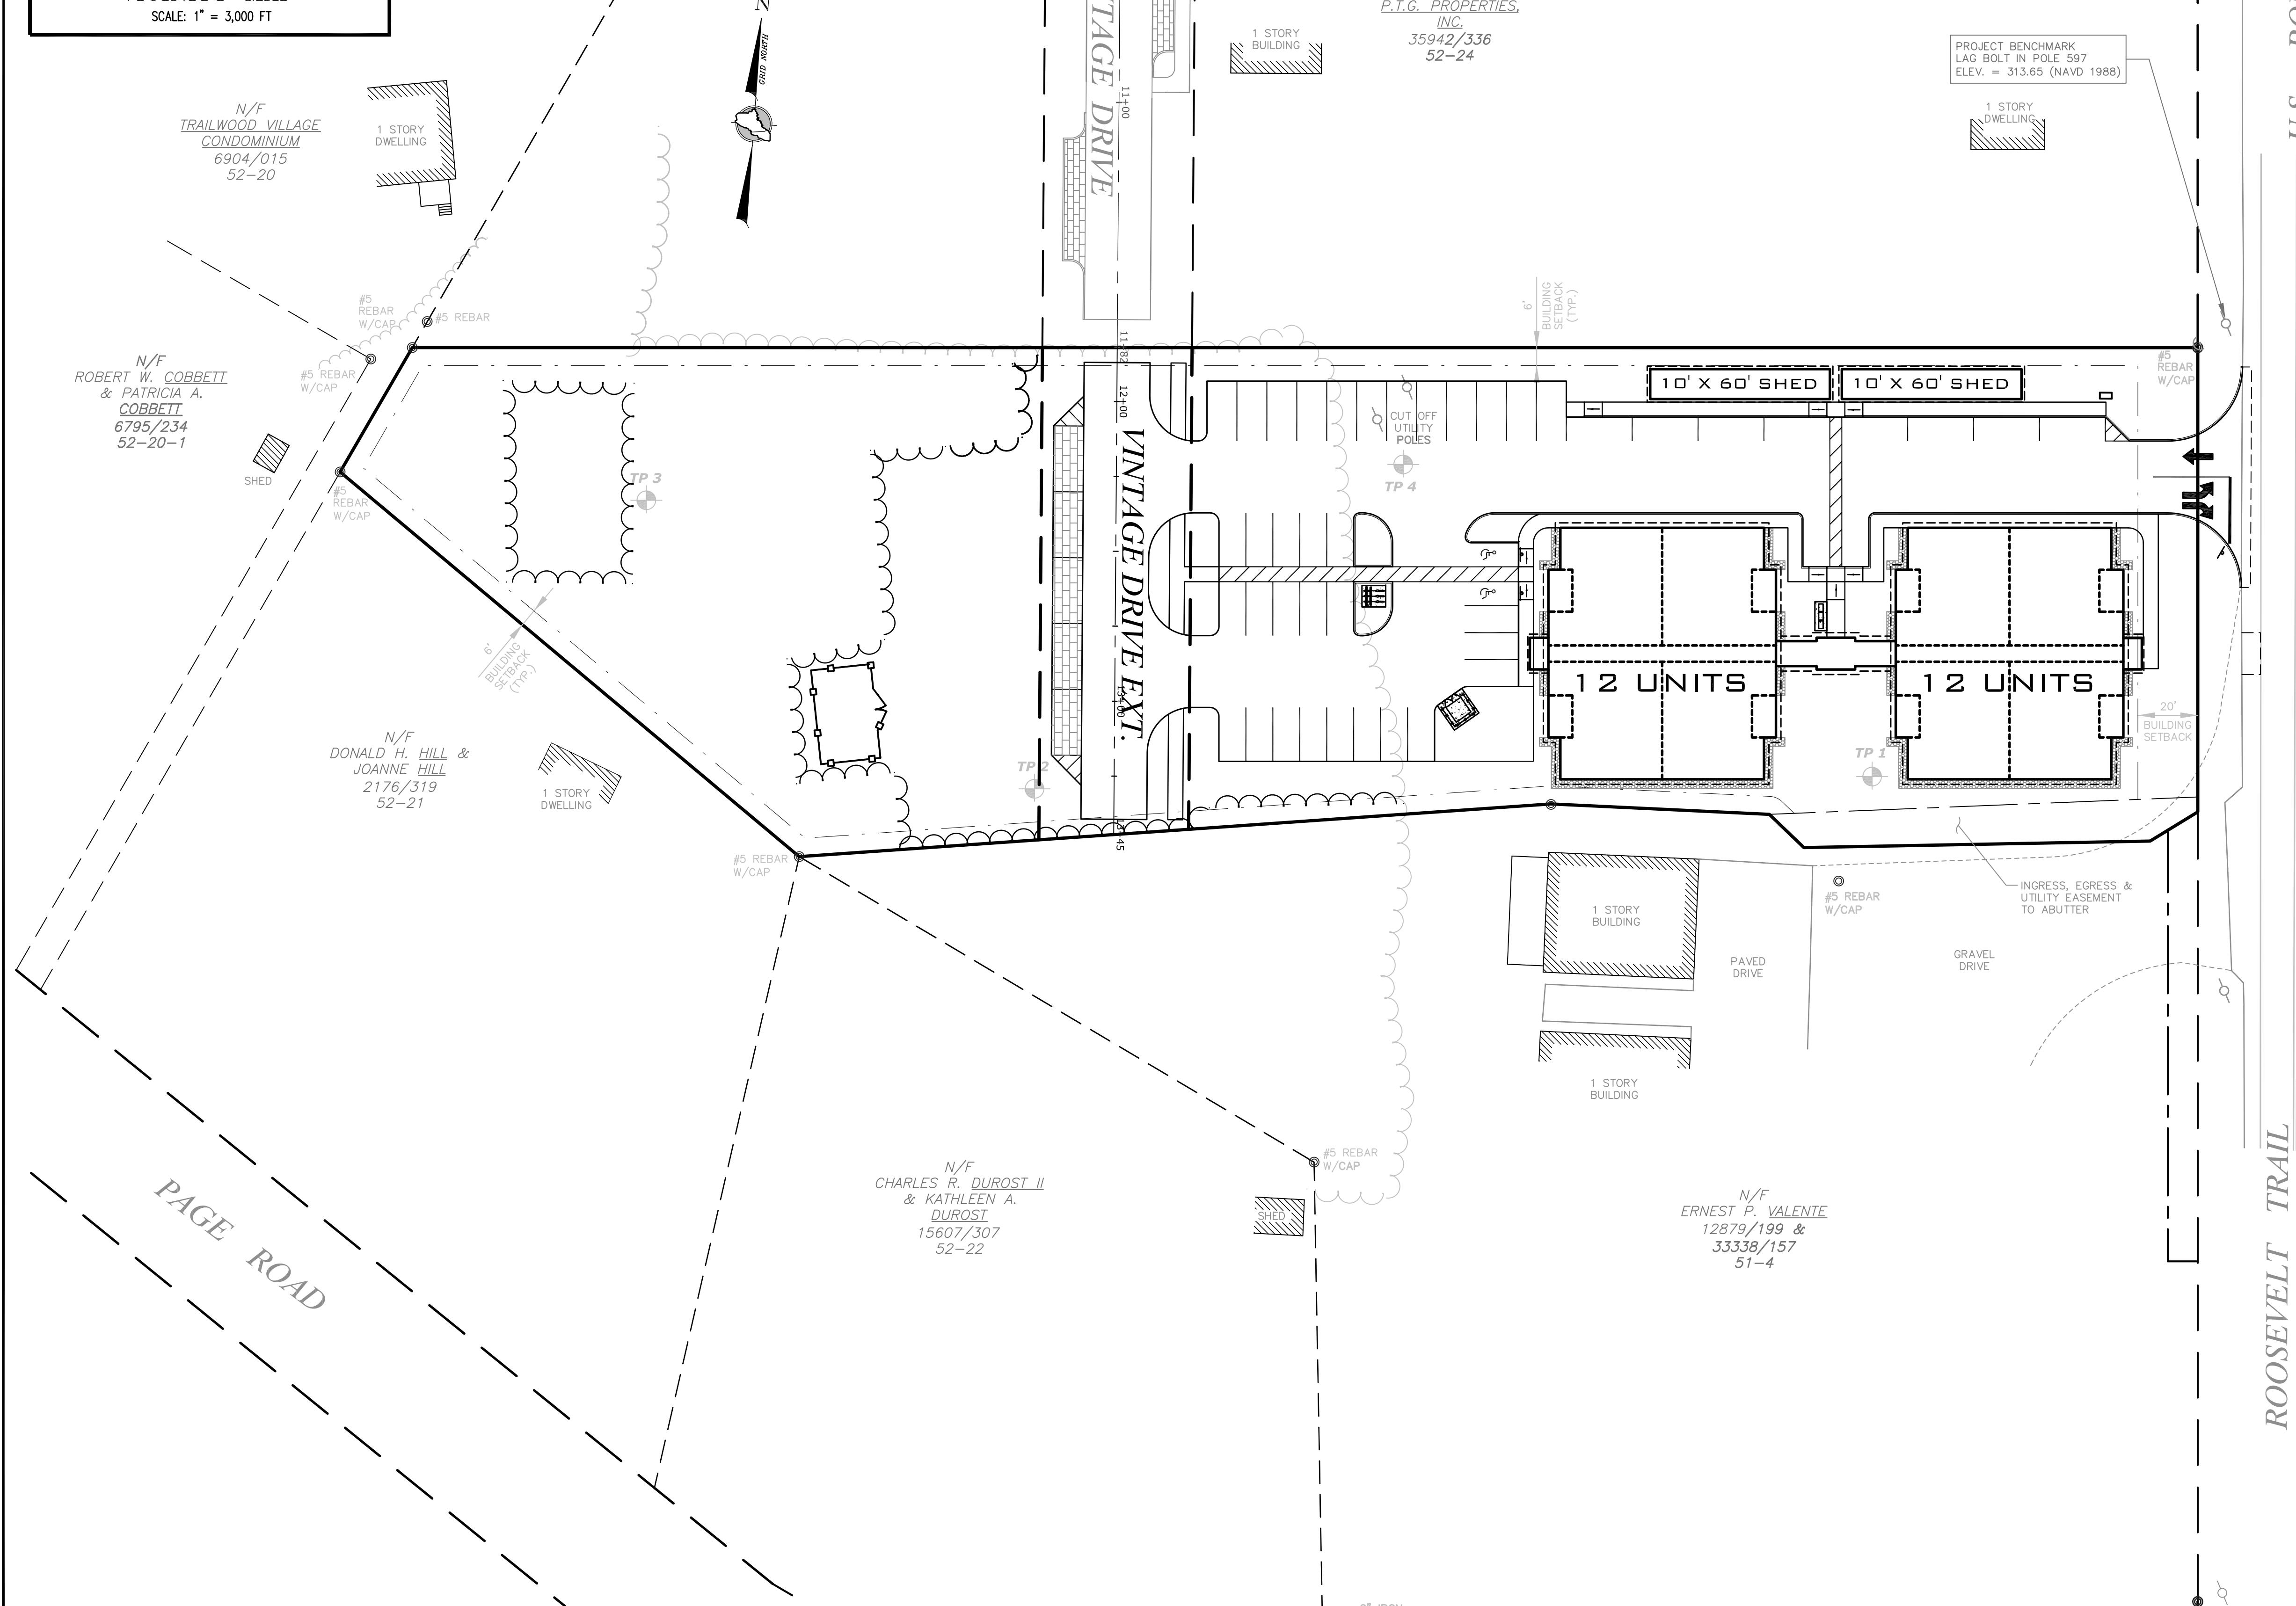


FIELDING CONDOS

ROOSEVELT TRAIL, WINDHAM, MAINE

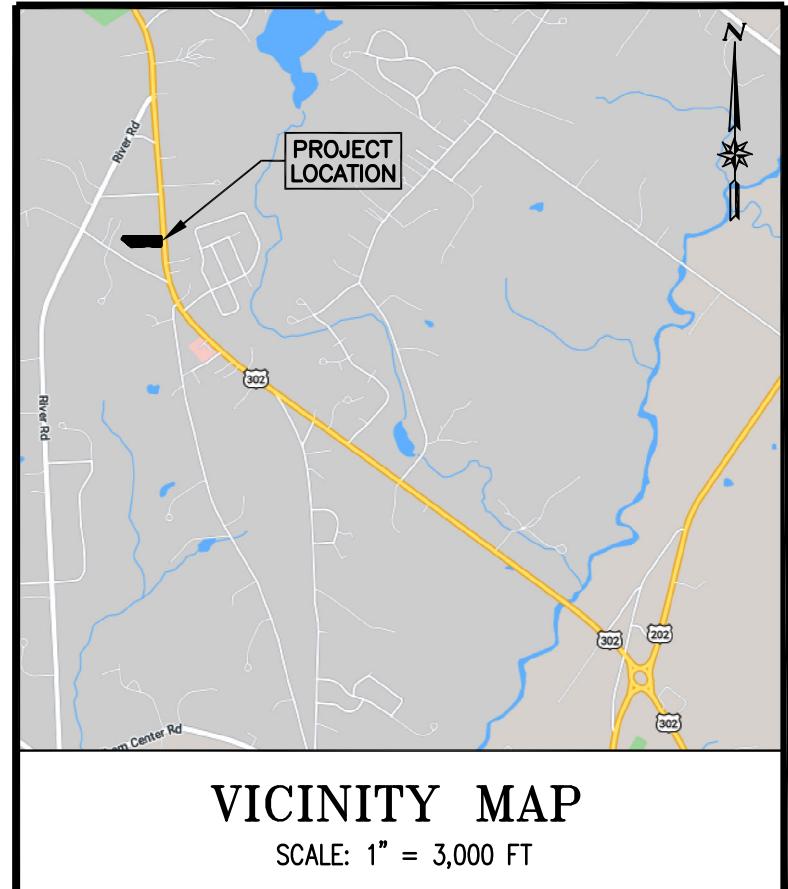

U.S. ROUTE 302

ROOSEVELT TRAIL

INDEX

1. COVER/INDEX/VICINITY MAP
2. BOUNDARY & TOPOGRAPHIC SURVEY
3. SITE, LAYOUT & UTILITY PLAN
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5. GRADING & DRAINAGE PLAN
6. EROSION & SEDIMENTATION CONTROL PLAN
7. EROSION & SEDIMENTATION CONTROL NOTES AND DETAILS
8. CONSTRUCTION DETAILS - SHEET 1
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12. UNDERGROUND DETENTION DETAILS - SHEET 2
- LANDSCAPE PLAN
- SITE LIGHTING LAYOUT
- ARCHITECTURAL PLANS


ABUTTERS

ASSESSOR'S MAP	PARCEL NUMBER	OWNER'S NAME
51	4	ERNEST P. VALENTE 12879/199 & 33338/157, PAGE 157 BOOK 39865, PAGE 157
52	20	TRAILWOOD VILLAGE CONDOMINIUM 936 ROOSEVELT TRAIL, SUITE 13, WINDHAM, ME 04062 BOOK 6904, PAGE 015
52	20-1	ROBERT W. COBBETT & PATRICIA A. COBBETT 37 PAGE ROAD, WINDHAM, ME 04062 BOOK 6795, PAGE 234
52	21	DONALD H. HILL & JOANNE HILL 31 PAGE ROAD, WINDHAM, ME 04062 BOOK 2176, PAGE 319
52	22	CHARLES R. DUROST II & KATHLEEN A. DUROST 3 WELCH ROAD, WINDHAM, ME 04062 BOOK 15607, PAGE 307
52	24	P.T.G. PROPERTIES, INC. 75 LOCKLAND DRIVE, WINDHAM, ME 04062 BOOK 35942, PAGE 336

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INTENDED FOR CONSTRUCTION
OR RECORDING

Revision:	By:	Date:	Change:
3	SMA	3/16/20	ADDED PROPANE TANKS
2	SMA	1/6/20	REVISED PER TOWN COMMENTS

1 SMA 12/21/20 SUBMITTED FOR TOWN REVIEW

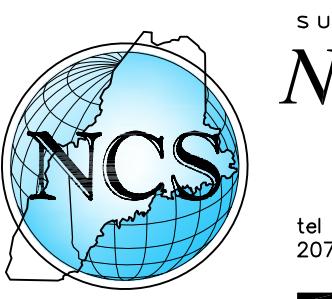PROJECT NUMBER: 41878	ACAD FILE: 41878-COVER.DWG	SCALE: 1" = 30'	DATE: DECEMBER 21, 2020
Drawing Name: COVER/INDEX/VICINITY PLAN			
Project Name: FIELDING CONDOS ROOSEVELT TRAIL, WINDHAM, MAINE			
Owner/Aplicant: FIELDING'S OIL CO., INC.			
 <p>Northeast Civil Solutions INCORPORATED SURVEYING • ENGINEERING • LAND PLANNING 381 PAYNE ROAD, SCARBOROUGH, MAINE 04074 tel 207.883.1000 fax 207.883.1001 e-mail info@northeastcivilsolutions.com www.northeastcivilsolutions.com</p>			
SHEET 1 OF 12			

LEGEND


BOUNDARY LINE
EDGE OF PAVEMENT
EDGE OF GRAVEL
RIGHT-OF-WAY LINE
ABUTTER
BUILDING SETBACK
EXISTING EASEMENT
EXISTING CATCH BASIN
EXISTING OVERHEAD UTILITIES
EXISTING UTILITY POLE
EXISTING WATER LINE
EXISTING WATER SHUT OFF
EXISTING GAS LINE
EXISTING TREE LINE
TESP PIT LOCATION
PROPOSED WATER LINE
PROPOSED FORCE MAIN
PROPOSED SEWER LINE
PROPOSED UNDERGROUND UTILITIES (ELECTRIC, TELEPHONE & CABLE)
PROPOSED PROPANE LINE
PROPOSED DRAIN LINE
PROPOSED OUTLET CONTROL STRUCTURE
PROPOSED CATCH BASIN
PROPOSED DRAIN MANHOLE
PROPOSED TREE LINE
PROPOSED PERMEABLE PAVER
PROPOSED DRAINAGE EASEMENT
STRIPING KEY:
SSY = SINGLE SOLID YELLOW
SSW = SINGLE SOLID WHITE
* SEE DETAILS FOR ADDITIONAL PAVEMENT MARKINGS

NOTES

1. SEPTIC SYSTEM SETBACKS:
 18' (MIN.) FROM PROPERTY LINE
 100' (MIN.) FROM OTHER DISPOSAL FIELD
 30' (MIN.) FROM BUILDING FOUNDATION
 100' (MIN.) FROM WELL

THIS PLAN IS FOR REVIEW PURPOSES ONLY AND IS NOT INTENDED FOR CONSTRUCTION OR RECORDING



Revision:	By:	Date:	Change:
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2	SMA	1/6/20	REVISED PER TOWN COMMENTS
1	SMA	12/21/20	SUBMITTED FOR TOWN REVIEW
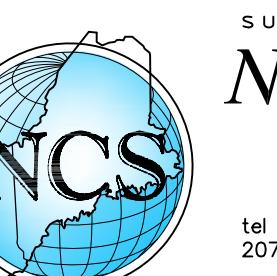
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Drawing Name:			
SITE, LAYOUT & UTILITY PLAN			
Project Name:			
FIELDING CONDOS ROOSEVELT TRAIL, WINDHAM, MAINE			
Owner/Agent:			
FIELDING'S OIL CO., INC.			
 Northeast Civil Solutions INCORPORATED SURVEYING • ENGINEERING • LAND PLANNING 381 PAYNE ROAD, SCARBOROUGH, MAINE 04074 tel 207.883.1000 fax 207.883.1001 e-mail / website info@northeastcivilsolutions.com www.northeastcivilsolutions.com			
SHEET 3 OF 12			






APPROVED BY THE TOWN OF
WINDHAM PLANNING BOARD

CHAIRPERSON	DATE

30" VERTICAL CMP W/CATCH BASIN RIM = 309.78 12" CMP INV. OUT = 307.88
--

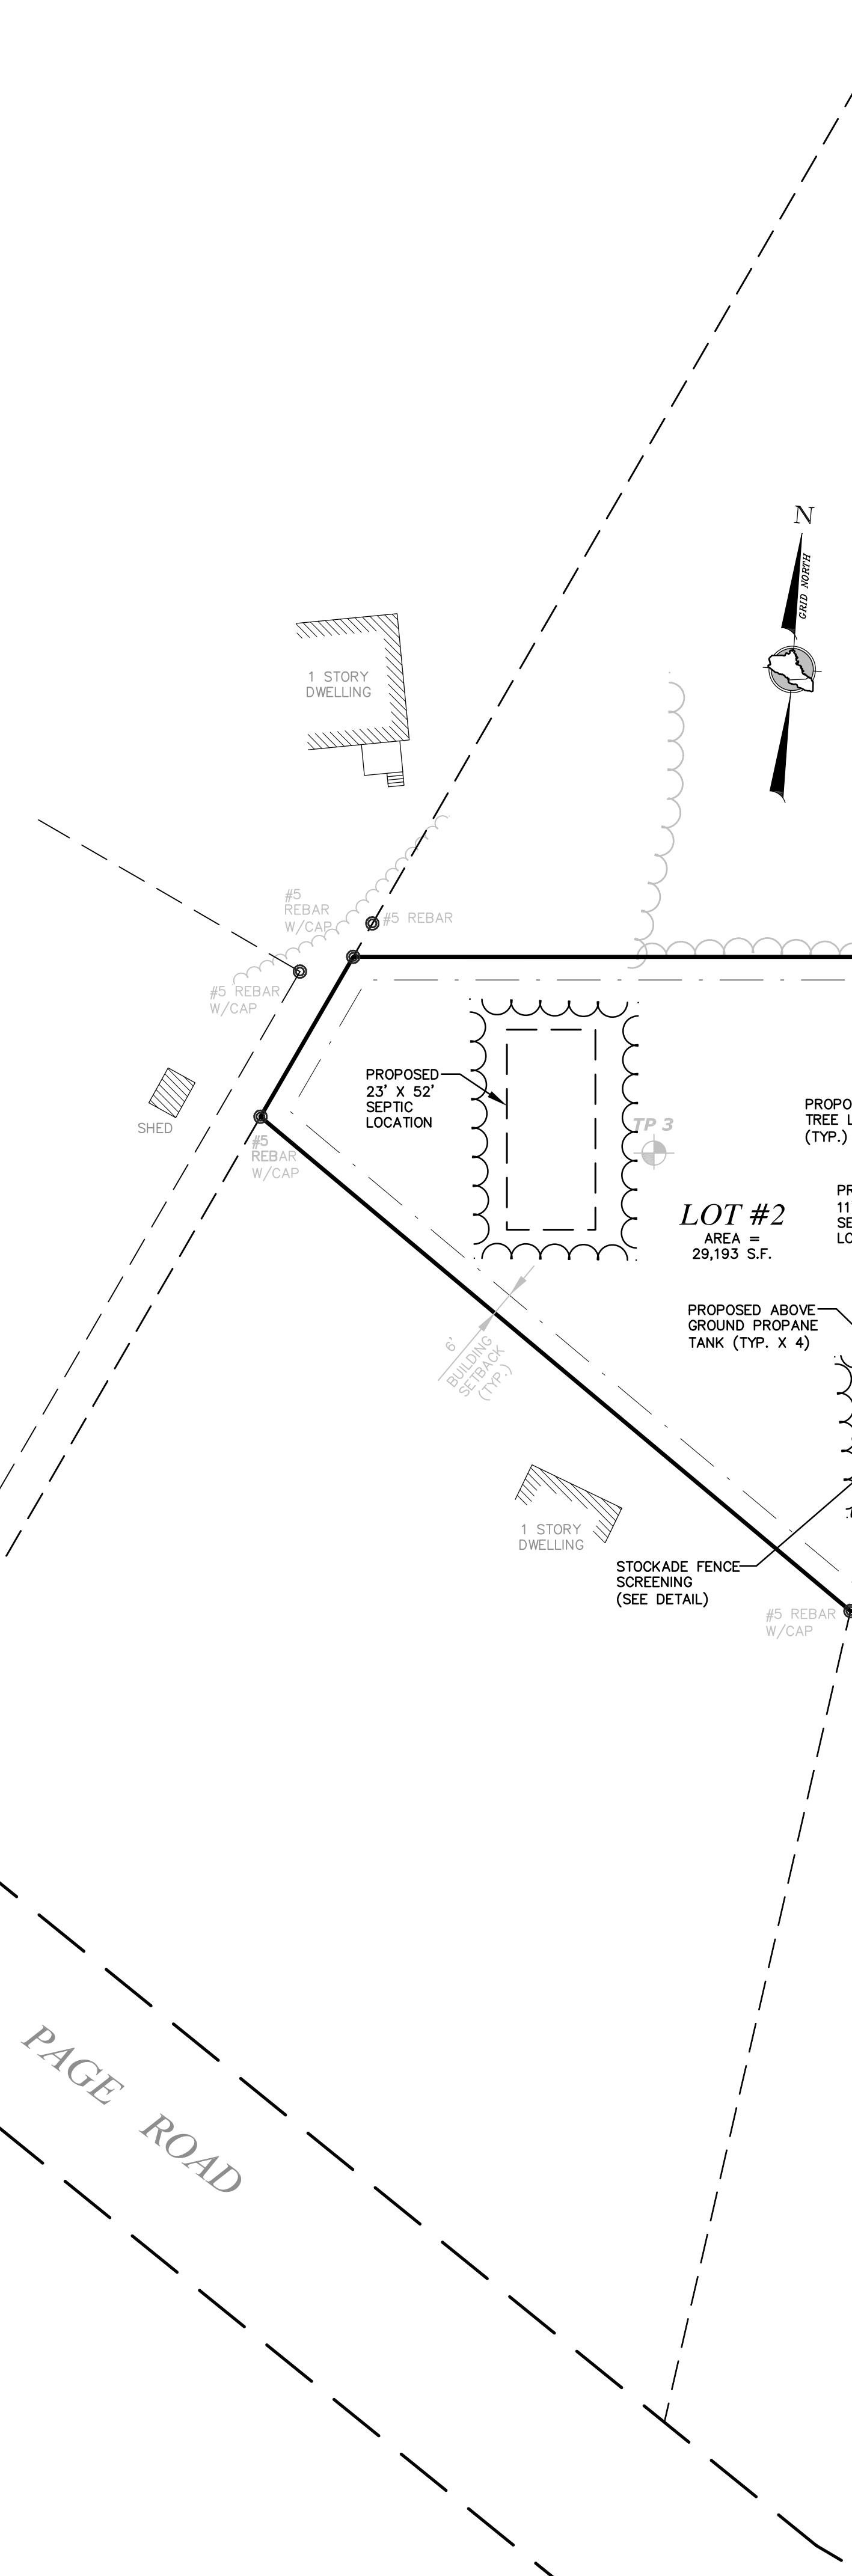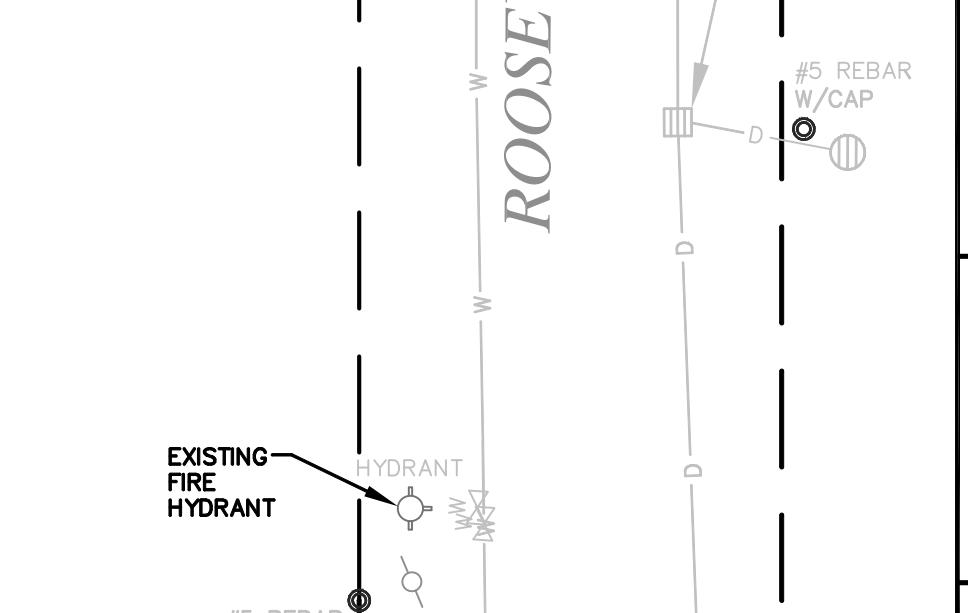

PAGE ROAD

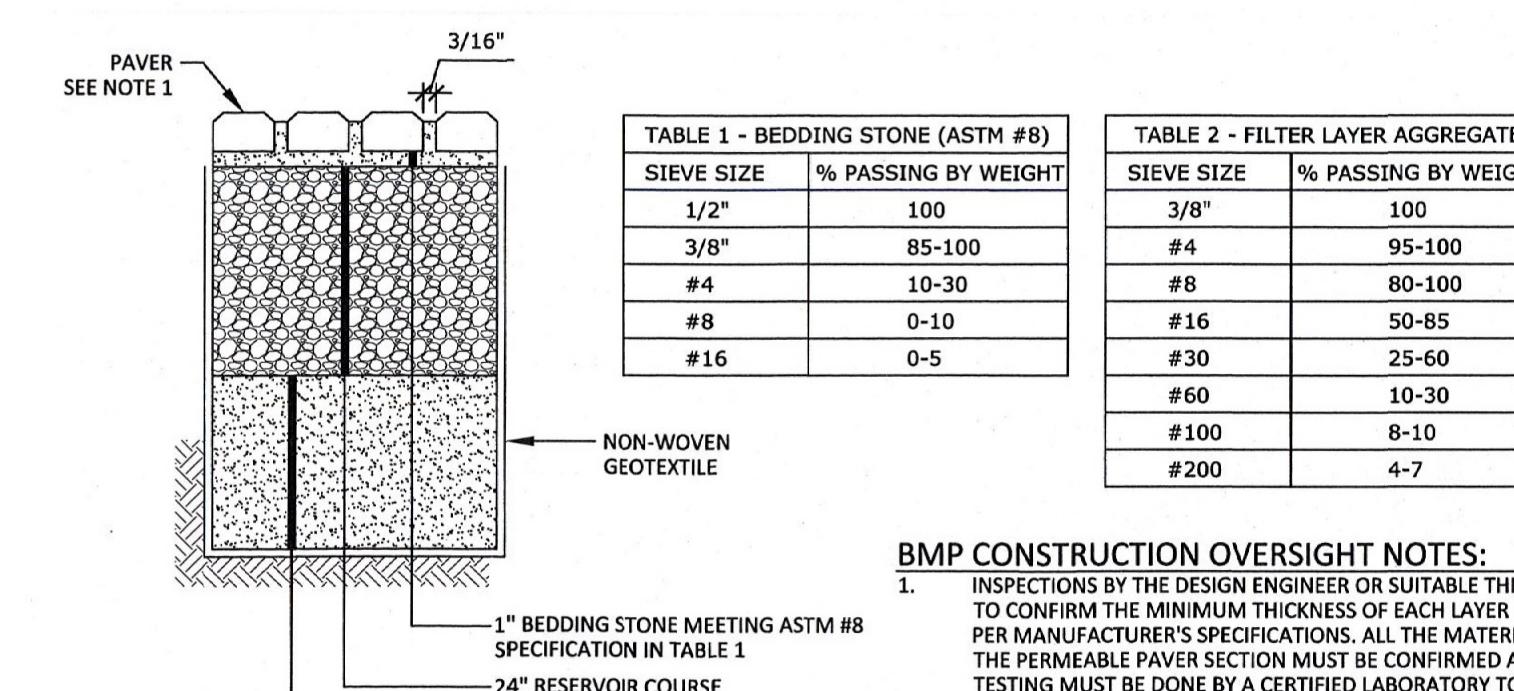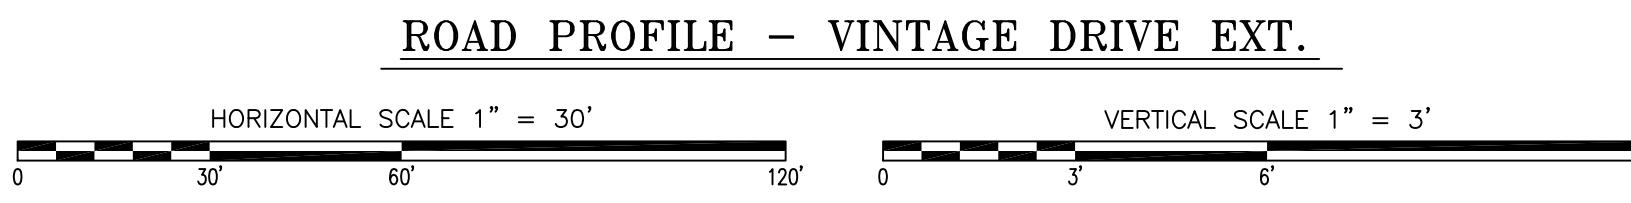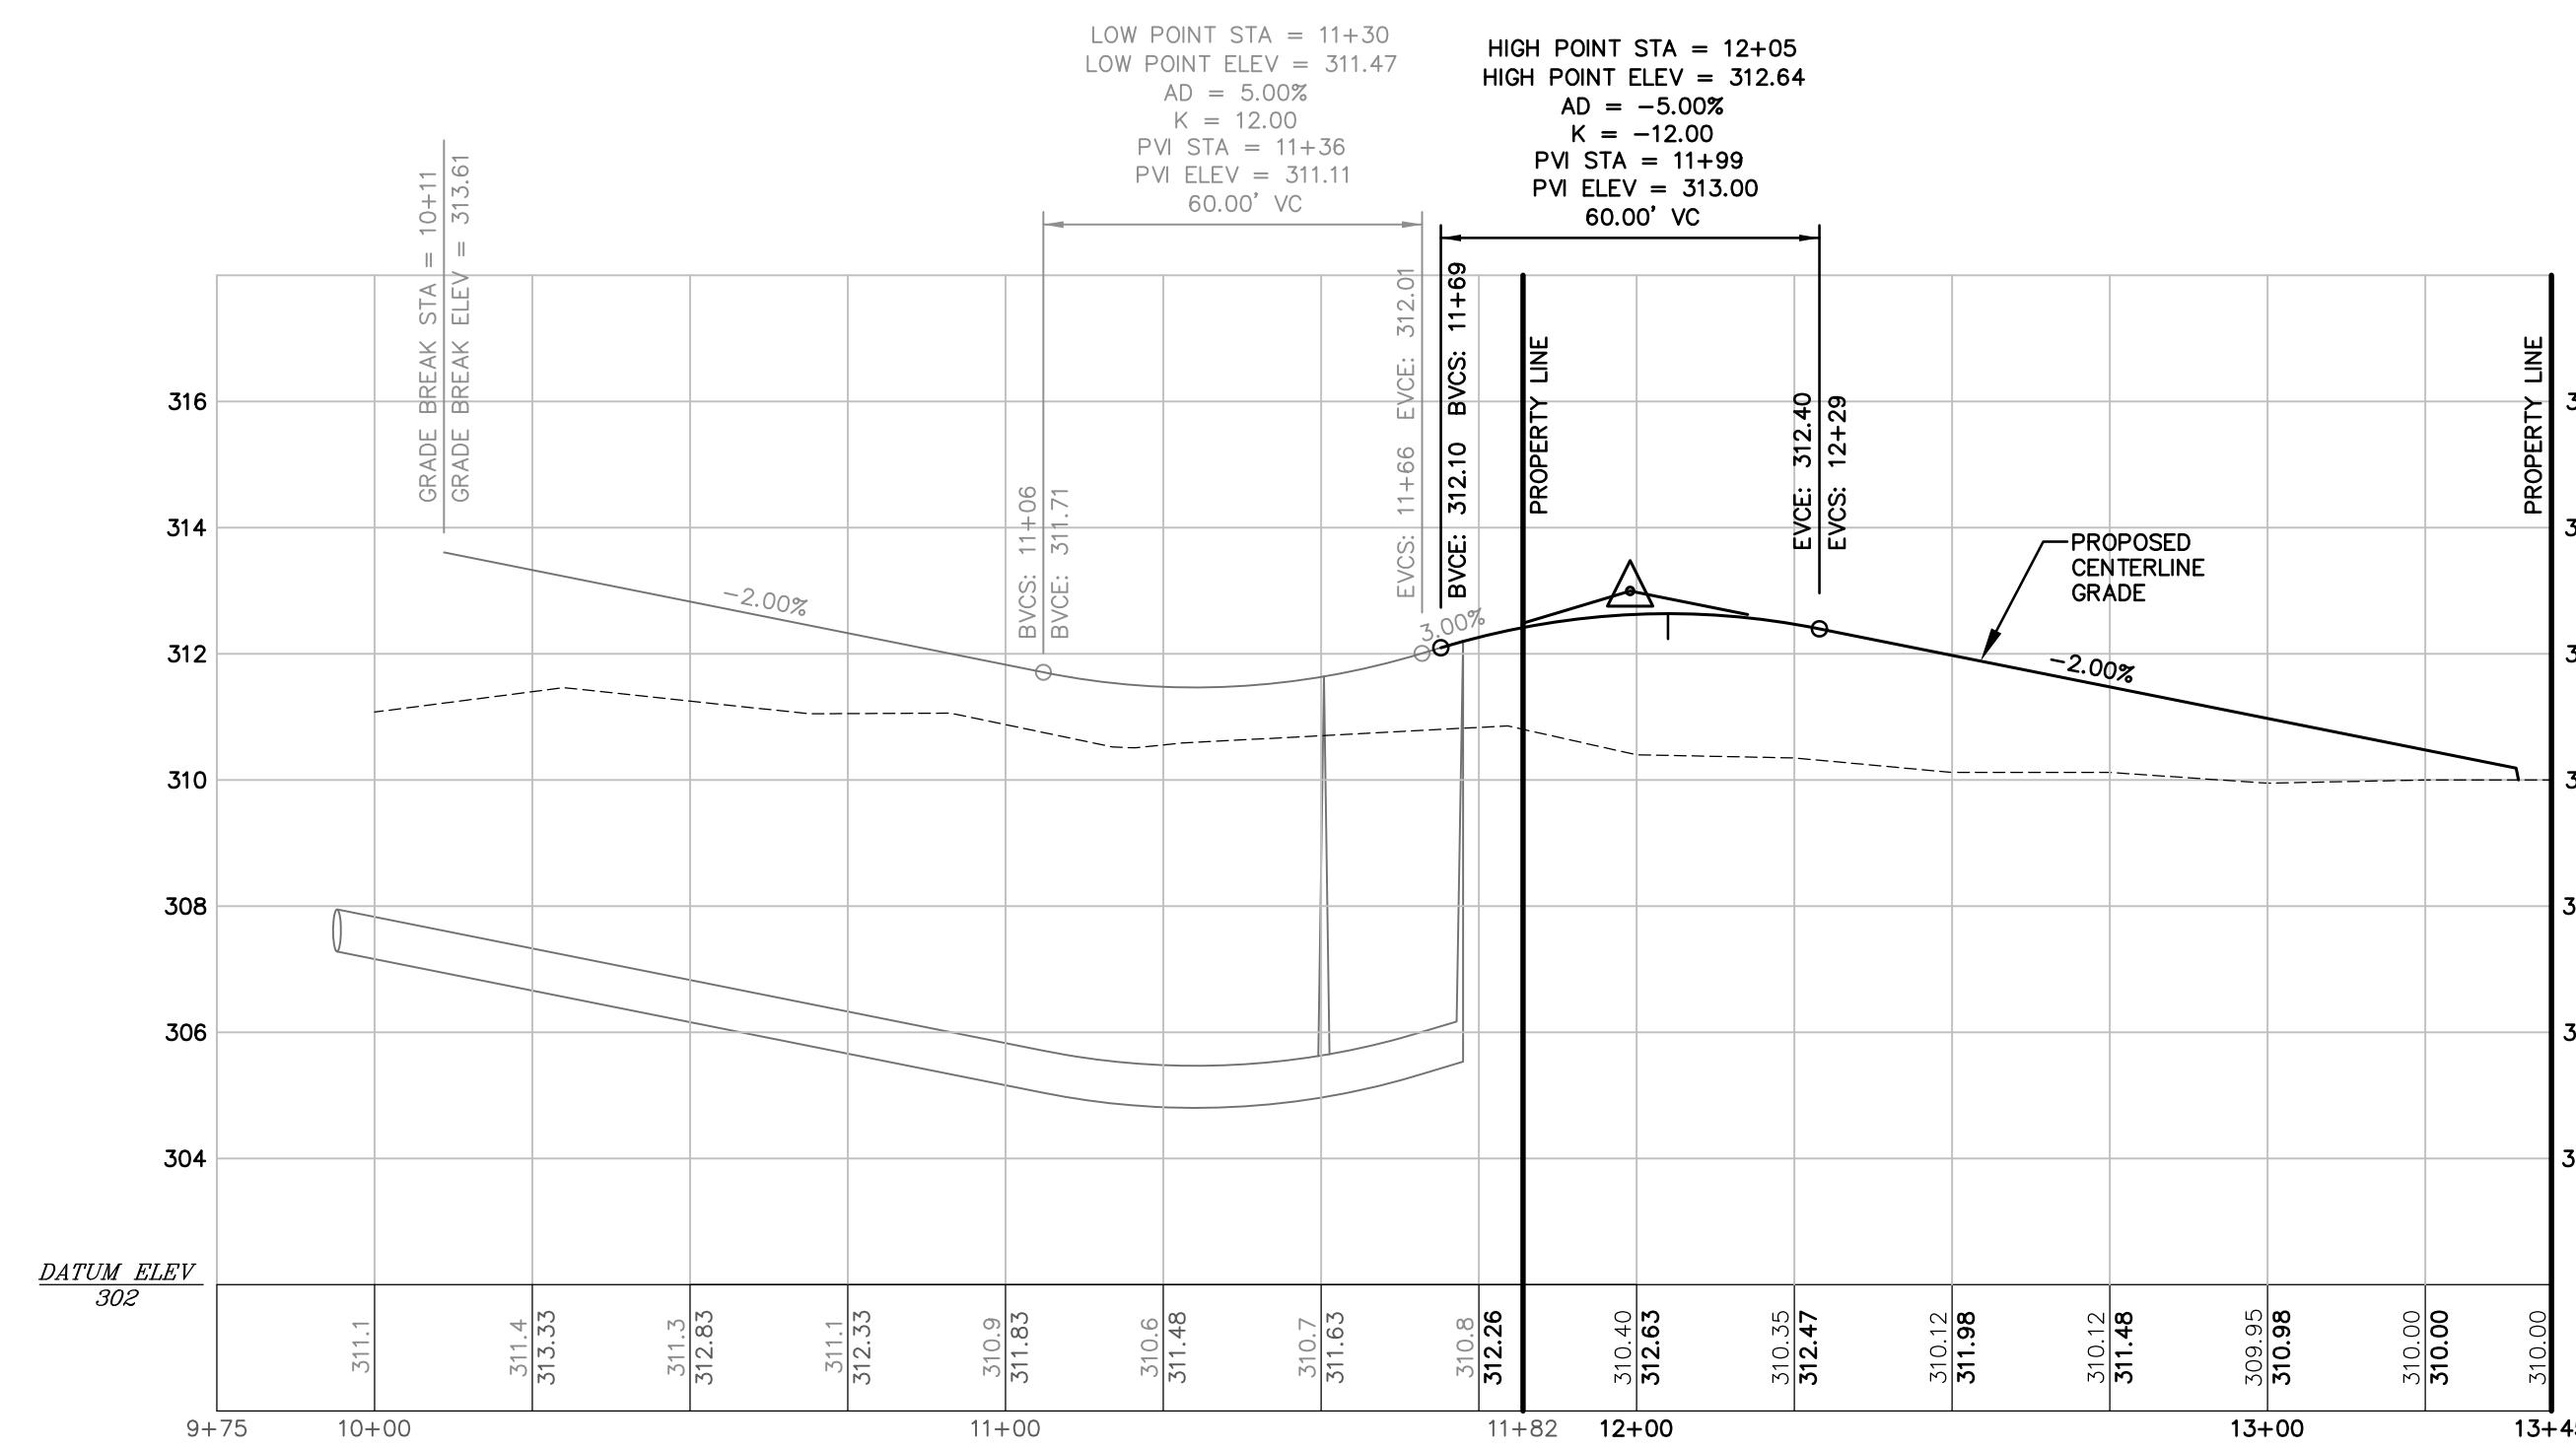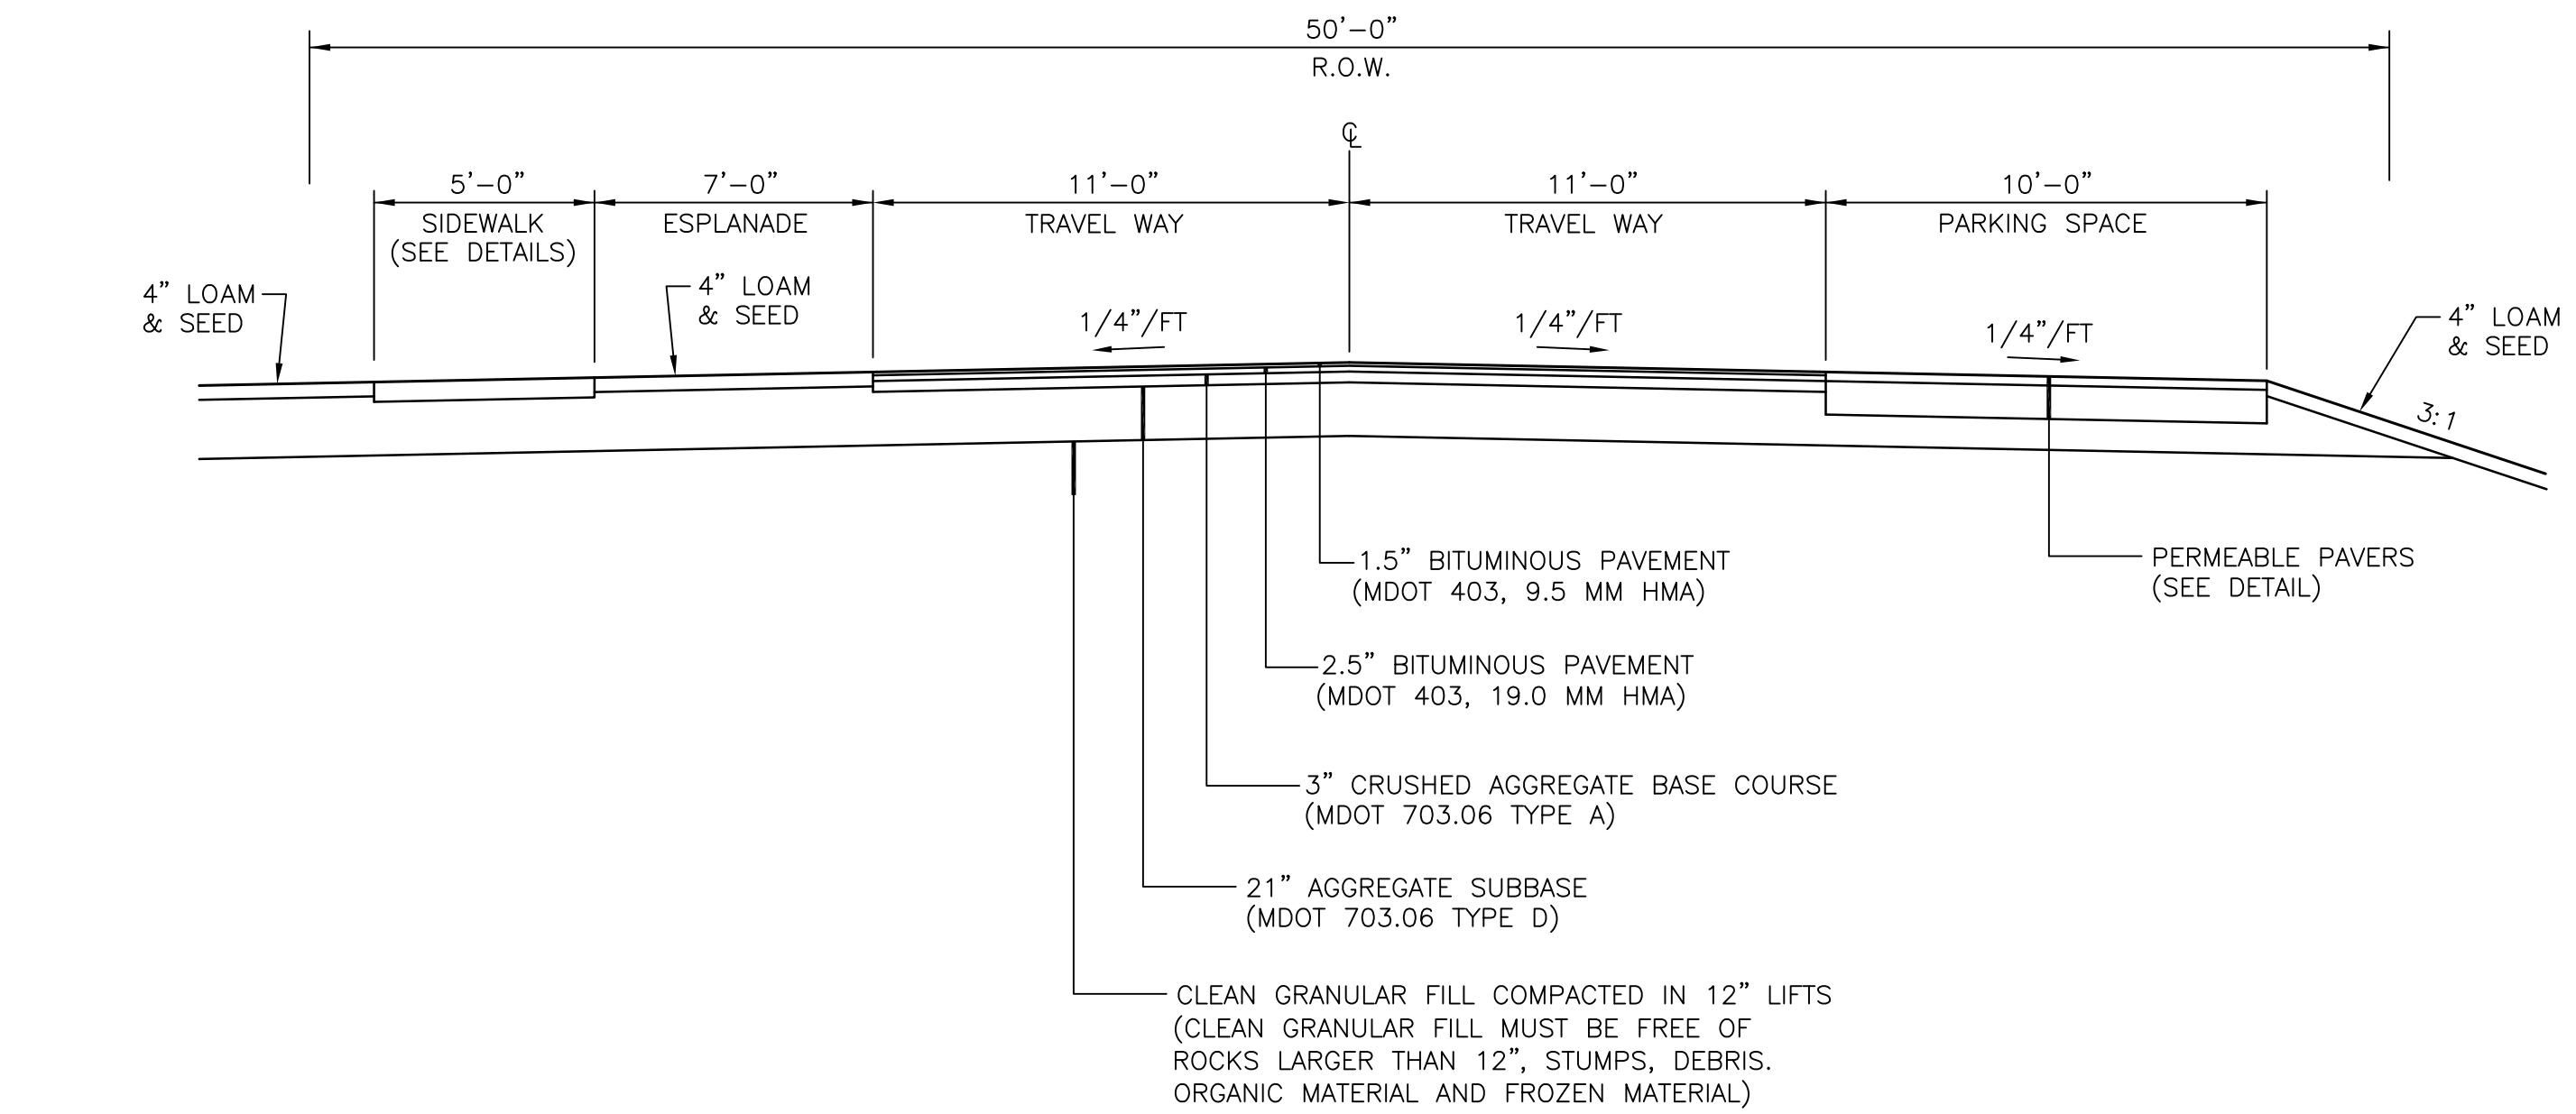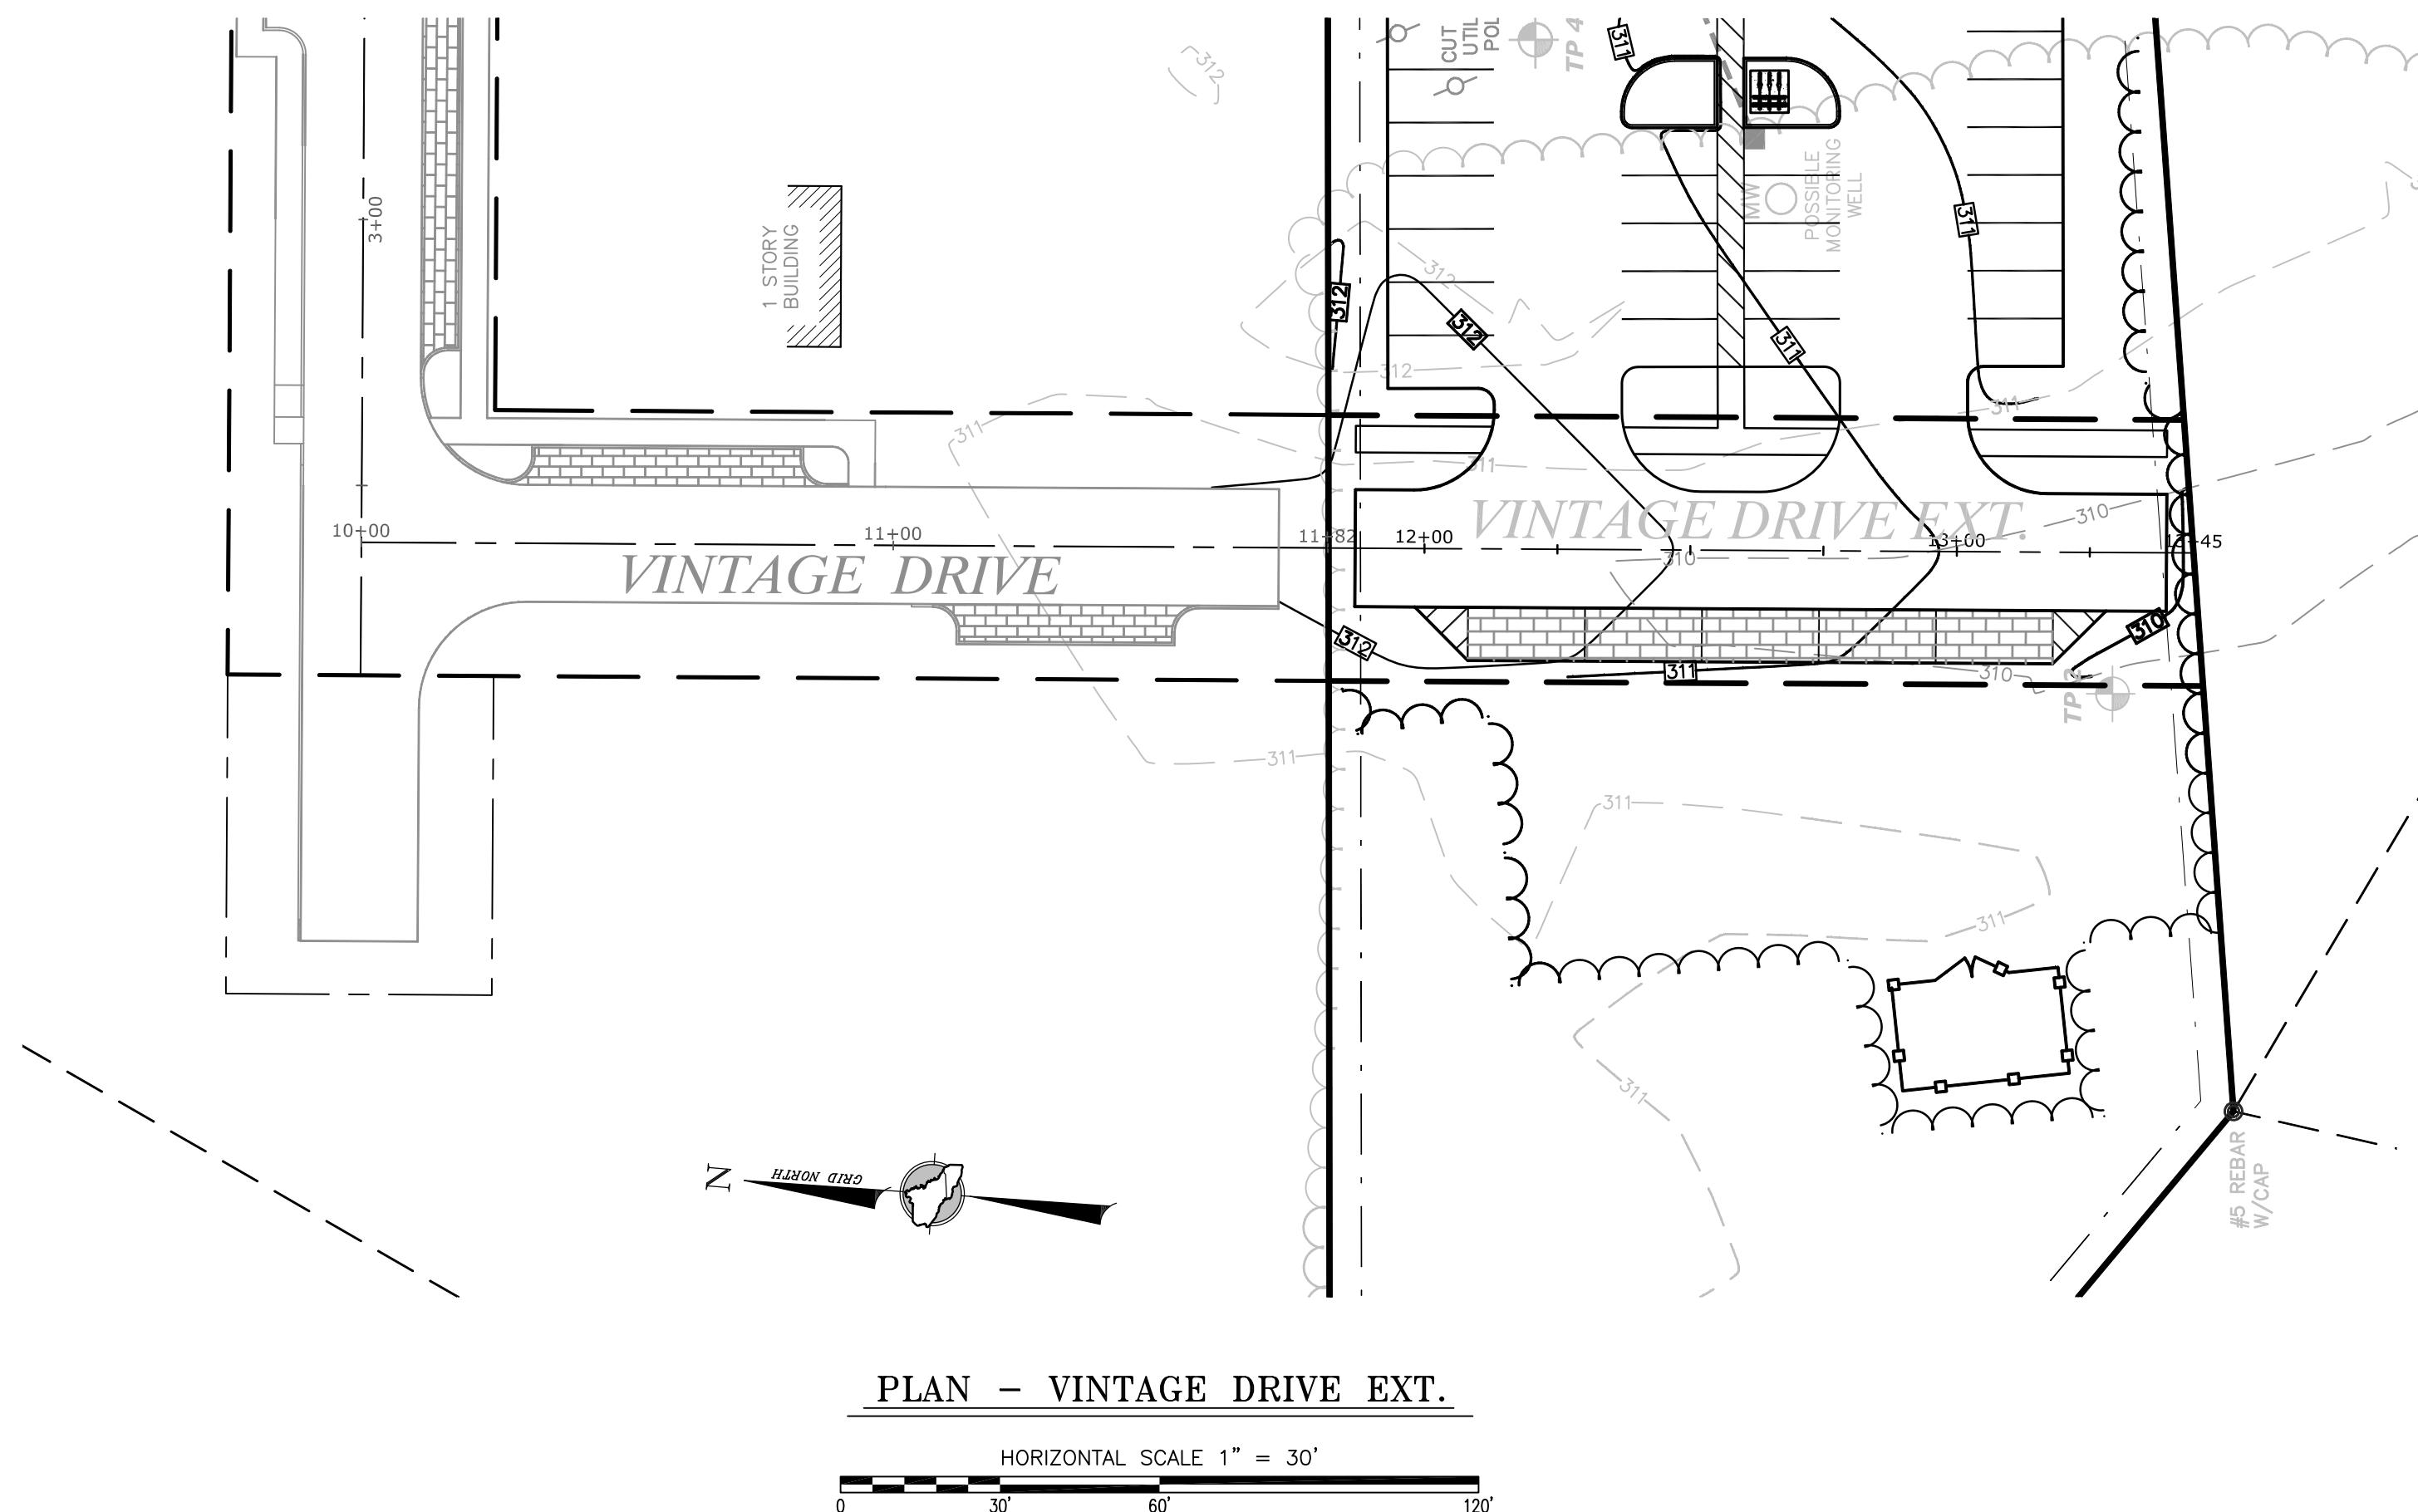

BMP CONSTRUCTION OVERSIGHT NOTES:

1. INSPECTIONS BY THE DESIGN ENGINEER OR SUITABLE THIRD PARTY WILL OCCUR AS NECESSARY TO CONFIRM THE MINIMUM THICKNESS OF EACH LAYER HAS BEEN PLACED AND COMPAKTED PER MANUFACTURER'S SPECIFICATIONS. ALL THE MATERIAL USED FOR THE CONSTRUCTION OF THE PERMEABLE PAVER SECTION MUST BE CONFIRMED AS SUITABLE BY THE DESIGN ENGINEER. TESTING MUST BE DONE BY A CERTIFIED LABORATORY TO SHOW THAT THEY ARE PASSING MDOT SPECIFICATIONS.
2. TESTING AND SUBMITTALS: THE CONTRACTOR SHALL IDENTIFY THE LOCATION OF THE SOURCE OF EACH COMPONENT OF THE PERMEABLE PAVER SECTION. ALL RESULTS OF FIELD AND LABORATORY TESTING SHALL BE SUBMITTED TO THE PROJECT ENGINEER FOR CONFIRMATION. THE CONTRACTOR SHALL:
 - a) SAMPLES OF THE FILTER LAYER, RESERVOIR COURSE AND BEDDING STONE SHALL BE COLLECTED. SAMPLES MUST BE A COMPOSITE OF THREE DIFFERENT LOCATIONS (GRABS) FROM THE STOCKPILE OR TILT FACE. SAMPLE SIZE REQUIRED WILL BE DETERMINED BY THE DESIGN ENGINEER.
 - b) PERFORM A SIEVE ANALYSIS CONFORMING TO ASTM C136 (STANDARD TEST METHOD FOR SIEVE ANALYSIS OF FINE AND COARSE AGGREGATES 1996A) ON EACH TYPE OF THE SAMPLE MATERIAL. THE RESULTING FILTER MEDIA MIXTURE MUST HAVE 4% TO 7% BY WEIGHT PASSING THE #200 SIEVE AND A CLAY CONTENT OF LESS THAN 2% (DETERMINED BY HYDROMETER GRAIN SIZE ANALYSIS)


GENERAL NOTES:

1. PAVERS SHALL BE STORMWATER BRICK AS MANUFACTURED BY GENEST CONCRETE WORKS, INC. OR APPROVED EQUAL PAVERS TO BE INSTALLED PER MANUFACTURER SPECIFICATIONS.

PERMEABLE PAVER DETAIL
NOT TO SCALE

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Revision:	By:	Date:	Change:
3	SMA	3/16/20	ADDED PROPANE TANKS
2	SMA	1/6/20	REVISED PER TOWN COMMENTS
1	SMA	12/21/20	SUBMITTED FOR TOWN REVIEW

PROJECT NUMBER: 41878	ACAD FILE: 41878-SITE.DWG	SCALE: 1" = 30'	DATE: DECEMBER 21, 2020
Drawing Name: PLAN & PROFILE			
Project Name: FIELDING CONDOS ROOSEVELT TRAIL, WINDHAM, MAINE			
Owner/Aplicant: FIELDING'S OIL CO., INC.			
 <p>Northeast Civil Solutions INCORPORATED SURVEYING • ENGINEERING • LAND PLANNING 381 PAYNE ROAD, SCARBOROUGH, MAINE 04074 tel 207.883.1000 fax 207.883.1001 e-mail / website info@northeastcivilsolutions.com www.northeastcivilsolutions.com</p>			
SHEET 4 OF 12			

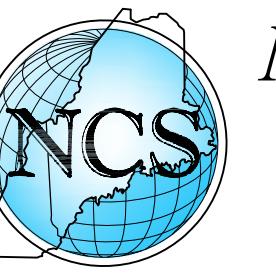LEGEND

BOUNDARY LINE
EDGE OF PAVEMENT
EDGE OF GRAVEL
RIGHT-OF-WAY LINE
ABUTTER
EXISTING CONTOUR
EXISTING EASEMENT
EXISTING CATCH BASIN
EXISTING UTILITY POLE
EXISTING TREE LINE
EXISTING CONTOUR
PROPOSED DRAIN LINE
PROPOSED OUTLET CONTROL STRUCTURE
PROPOSED CATCH BASIN
PROPOSED DRAIN MANHOLE
PROPOSED TREE LINE
PROPOSED CONTOUR
PROPOSED PERMEABLE PAVER
SPOT GRADE
LOW POINT
HIGH POINT
SURFACE GRADE
PROPOSED DRAINAGE EASEMENT

NOTES

STRUCTURE SCHEDULE				
STRUCTURE	RIM	INVERT IN	INVERT OUT	
CB-1	310.75	---	307.60 (SD1)	
CB-2	310.60	---	308.00 (SD-2)	
CB-3	320.60	---	308.00 (SD-3)	
DMH-1	311.40	306.50 (SD-1) 307.75 (SD-2) 307.75 (SD-3)	36.10 (SD-4)	
OCS-1		SEE DETAIL		


PIPE SCHEDULE				
PIPE	PIPE DIAMETER	PIPE LENGTH	PIPE SLOPE (FT/FT)	TYPE
SD-1	12"	110'	0.010	CORRUGATED HDPE (SMOOTH INTERIOR)
SD-2	12"	30'	0.010	CORRUGATED HDPE (SMOOTH INTERIOR)
SD-3	12"	30'	0.010	CORRUGATED HDPE (SMOOTH INTERIOR)
SD-4	12"	35'	0.000 FLAT	CORRUGATED HDPE (CORRODED INTERIOR)
SD-5	12"	10'	0.000 FLAT	CORRUGATED HDPE (SMOOTH INTERIOR)
SD-6	12"	20'	0.002	CORRUGATED HDPE (SMOOTH INTERIOR)
SD-7	12"	250'	0.002	CORRUGATED HDPE (SMOOTH INTERIOR)


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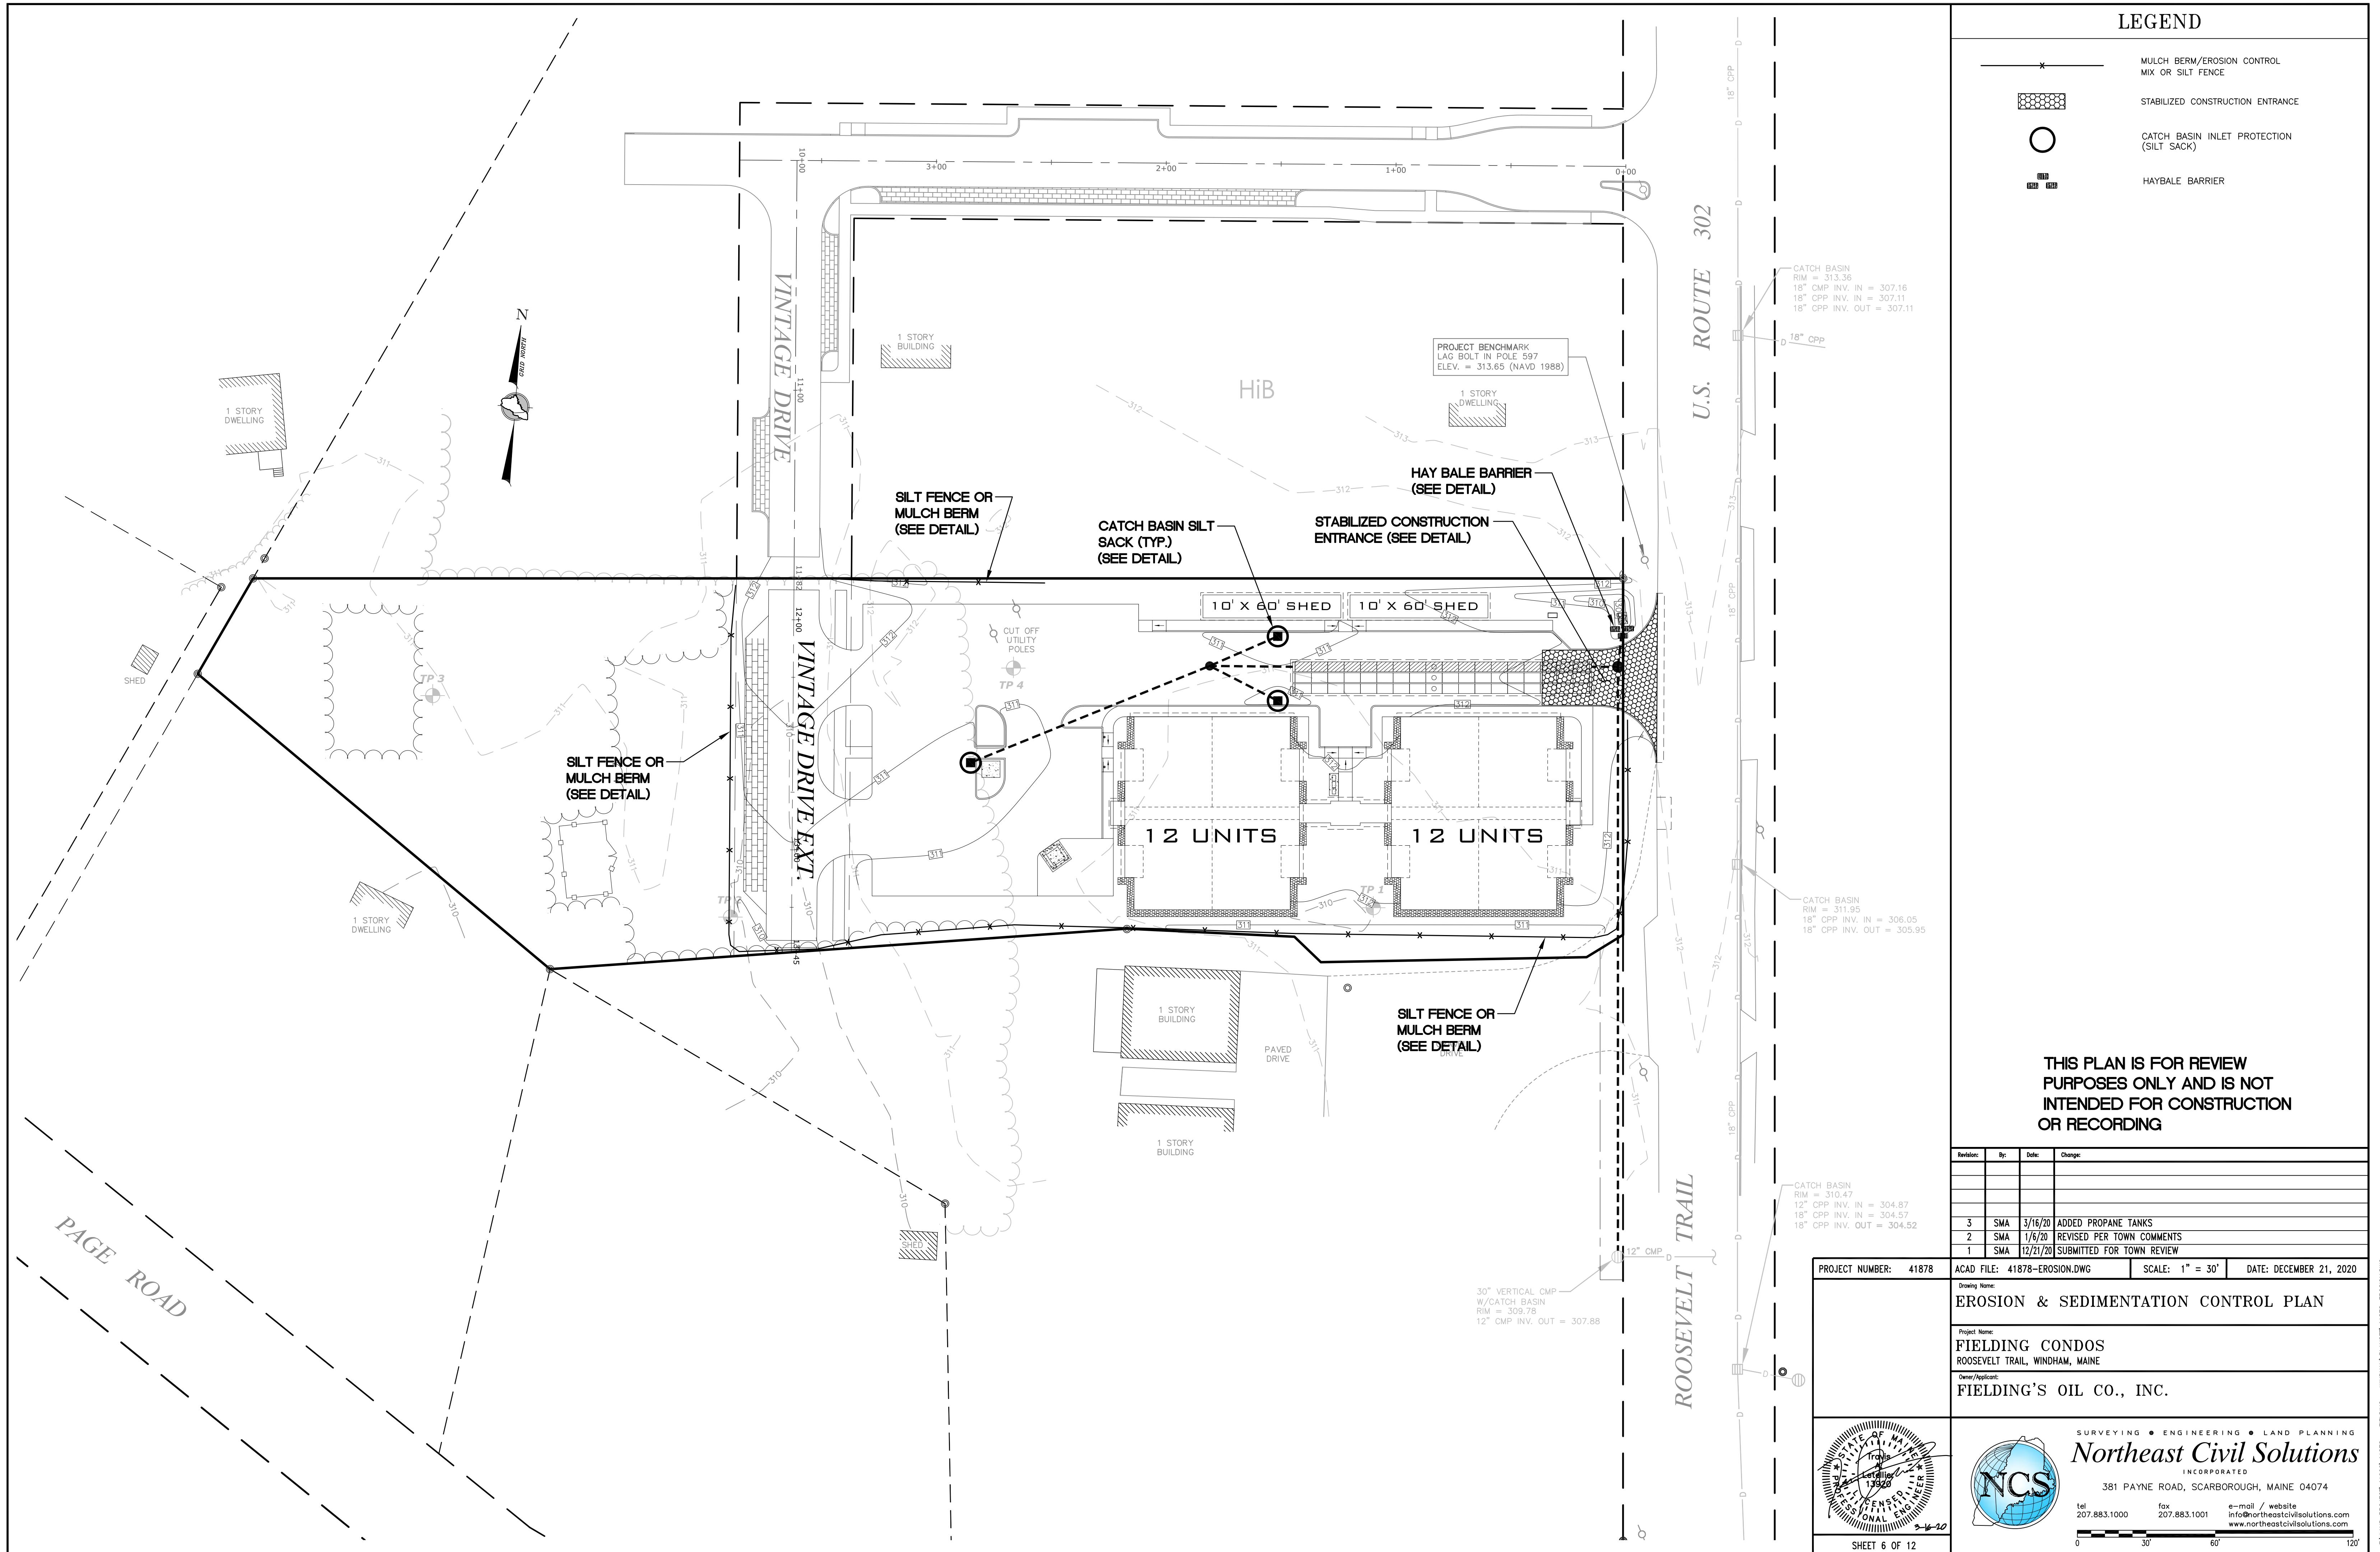
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1	SMA	12/21/20	SUBMITTED FOR TOWN REVIEW


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Drawing Name: GRADING & DRAINAGE PLAN			

Project Name: FIELDING CONDOS ROOSEVELT TRAIL, WINDHAM, MAINE
Owner/Aplicant: FIELDING'S OIL CO., INC.

 <p>Northeast Civil Solutions INCORPORATED</p> <p>381 PAYNE ROAD, SCARBOROUGH, MAINE 04074</p> <p>tel 207.883.1000 fax 207.883.1001 e-mail / website info@northeastcivilsolutions.com www.northeastcivilsolutions.com</p>	SURVEYING • ENGINEERING • LAND PLANNING
	0 30' 60' 120'

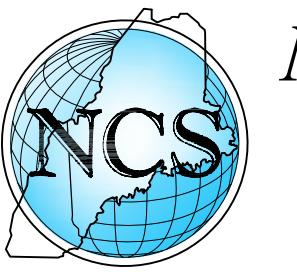


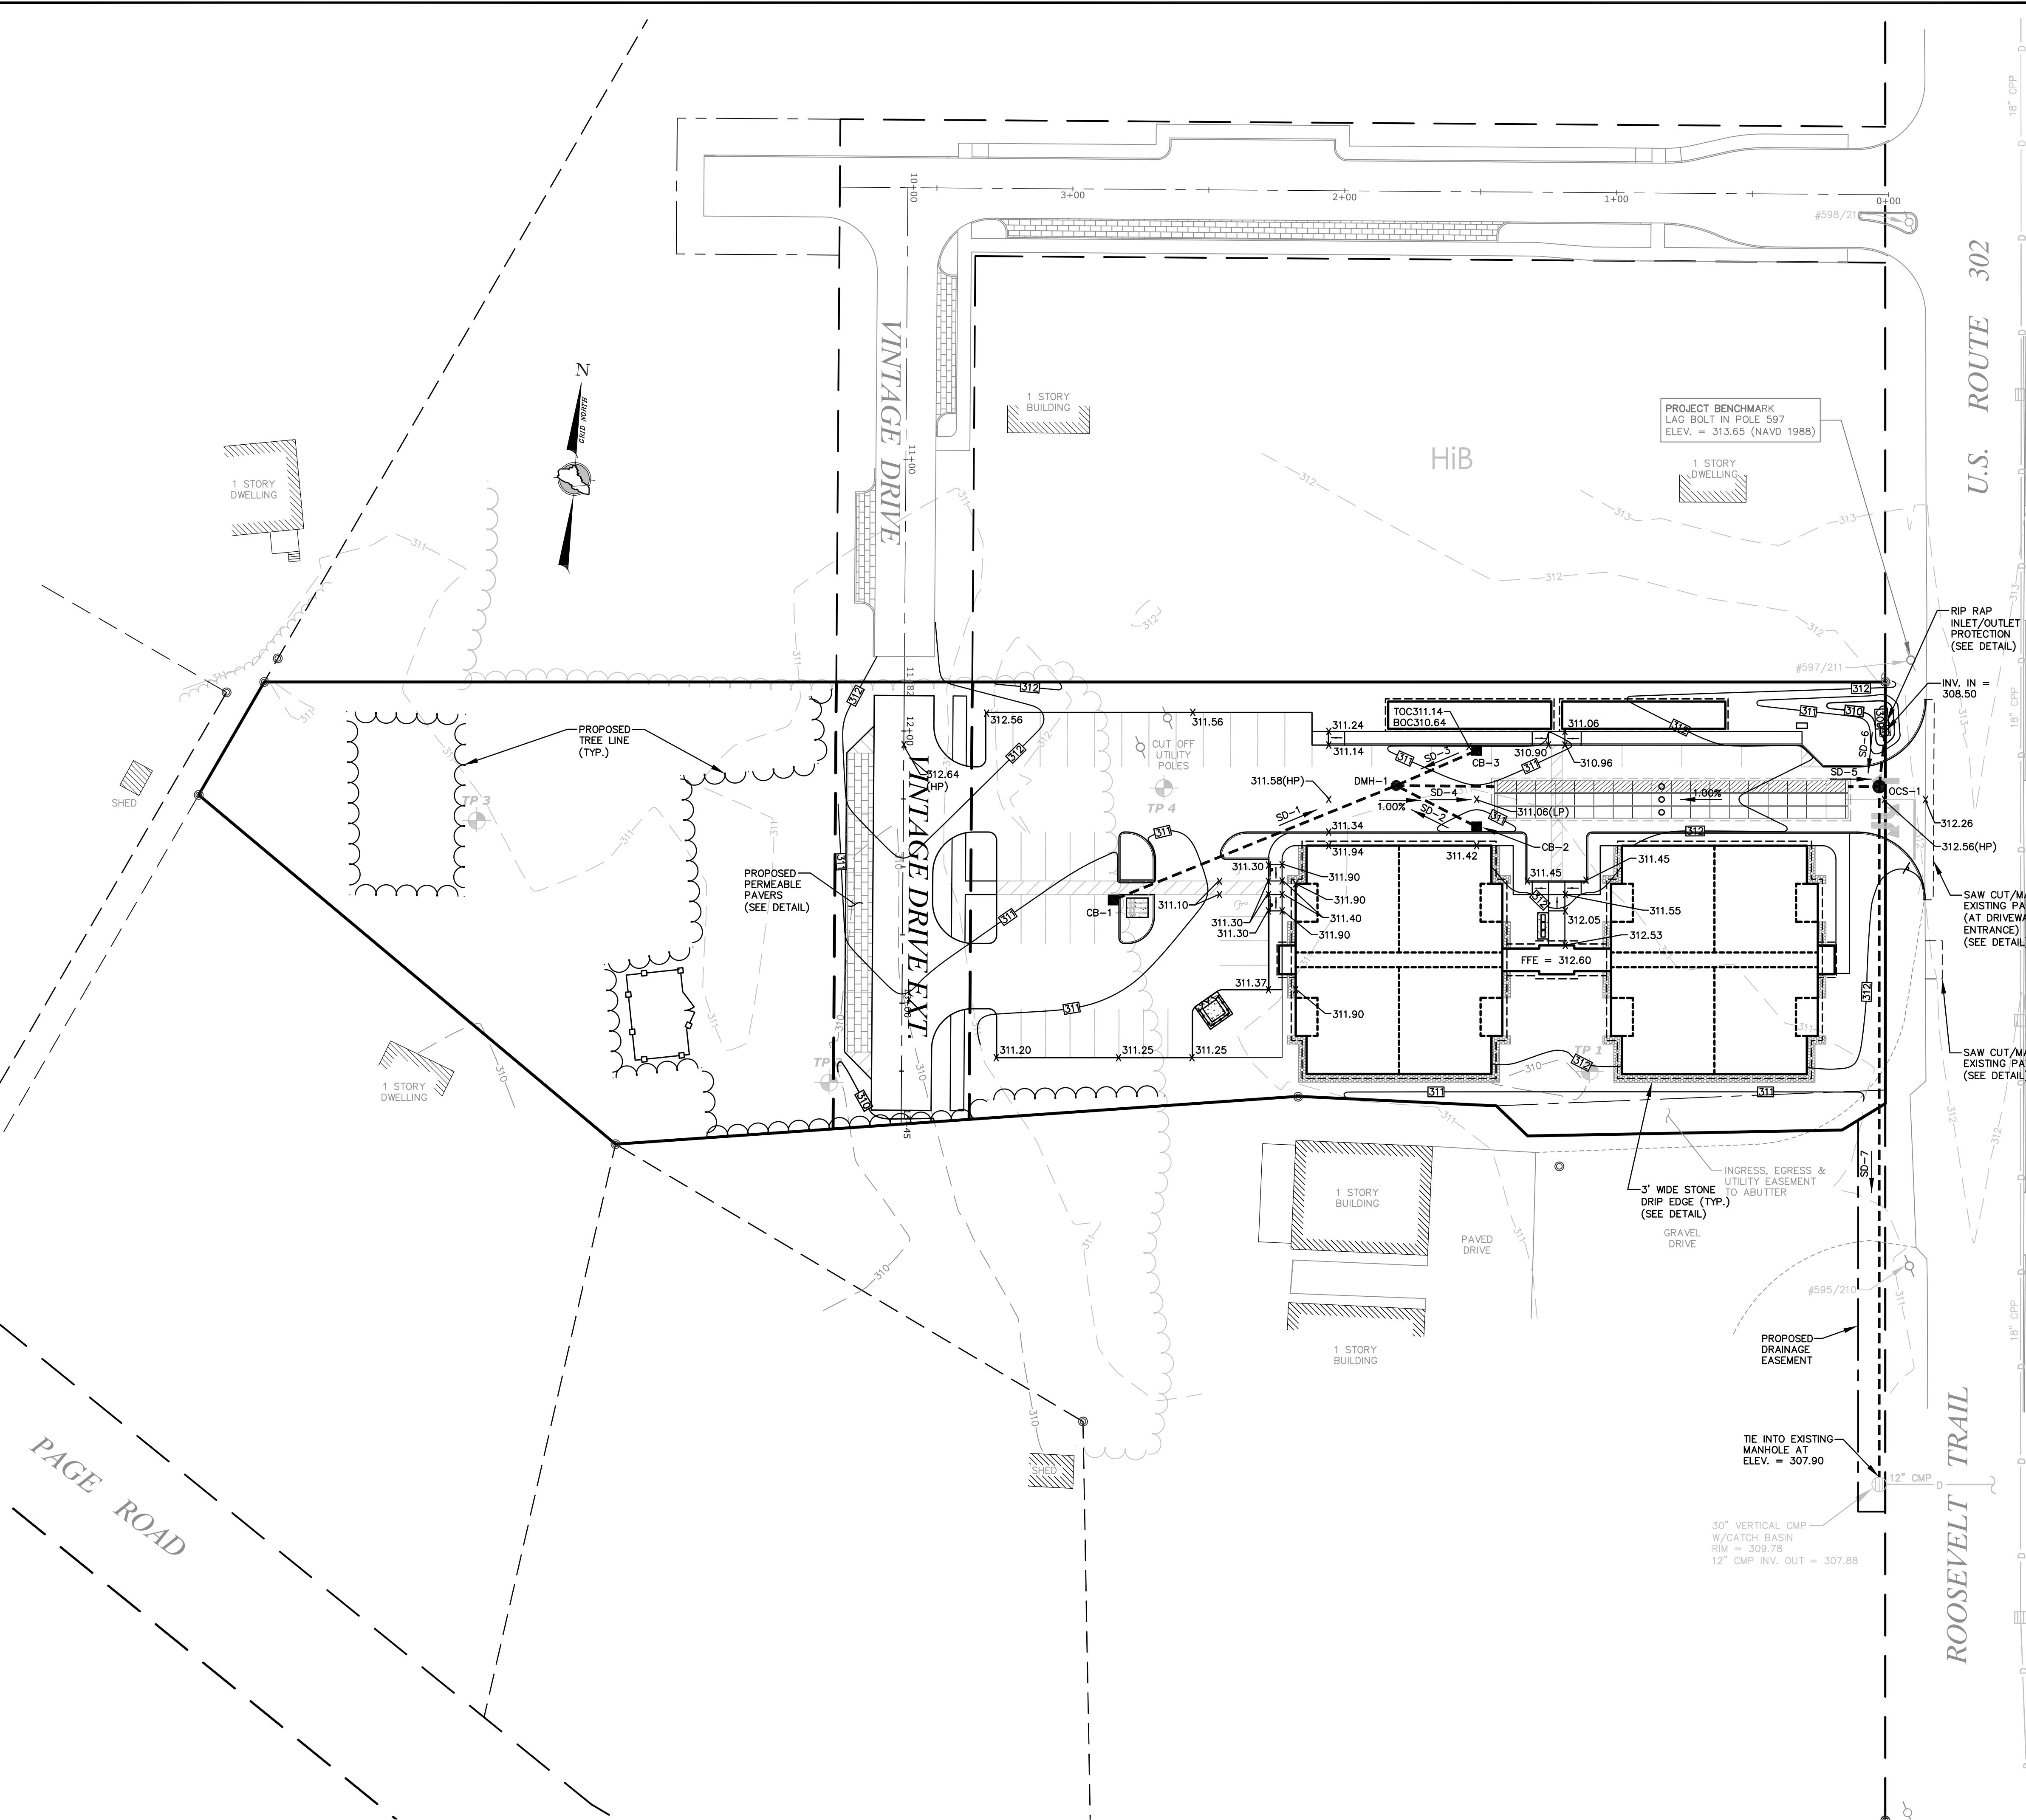

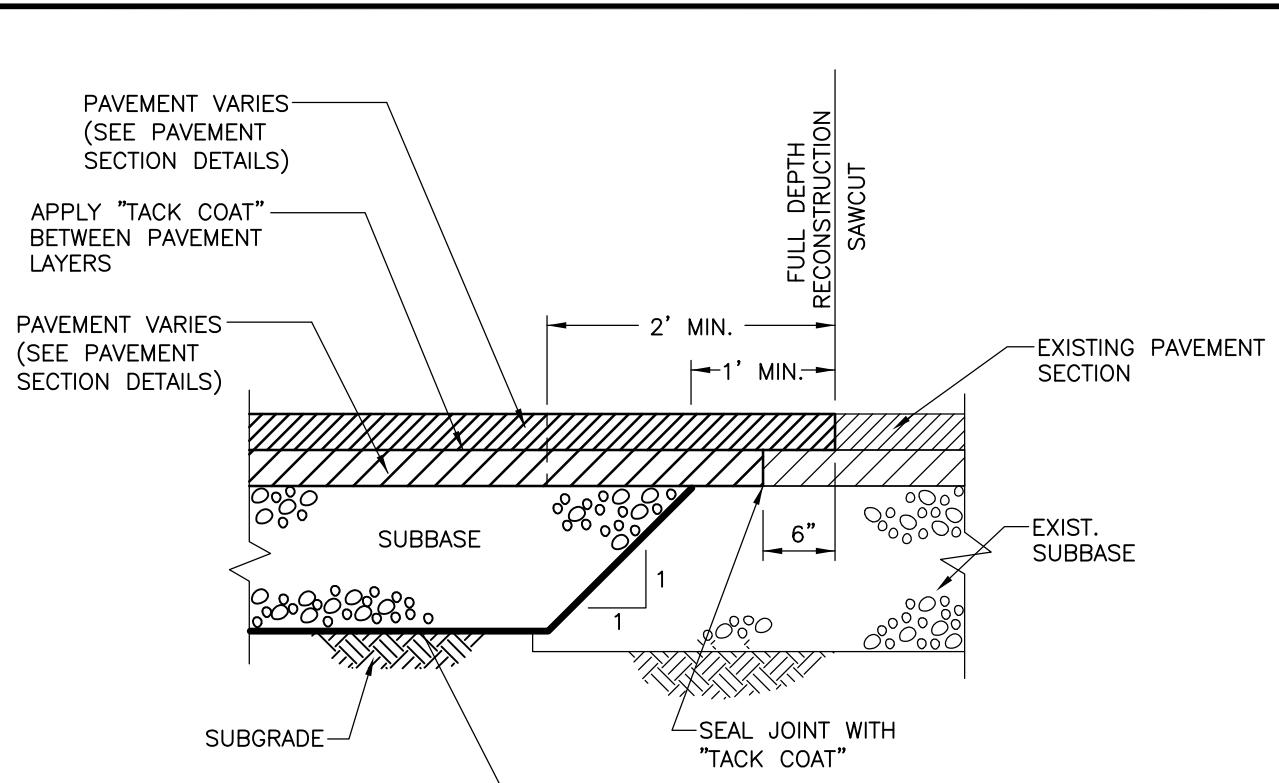


NOTE: PER MDOT ITEM 403

SAWCUT & PAVEMENT MATCH DETAIL



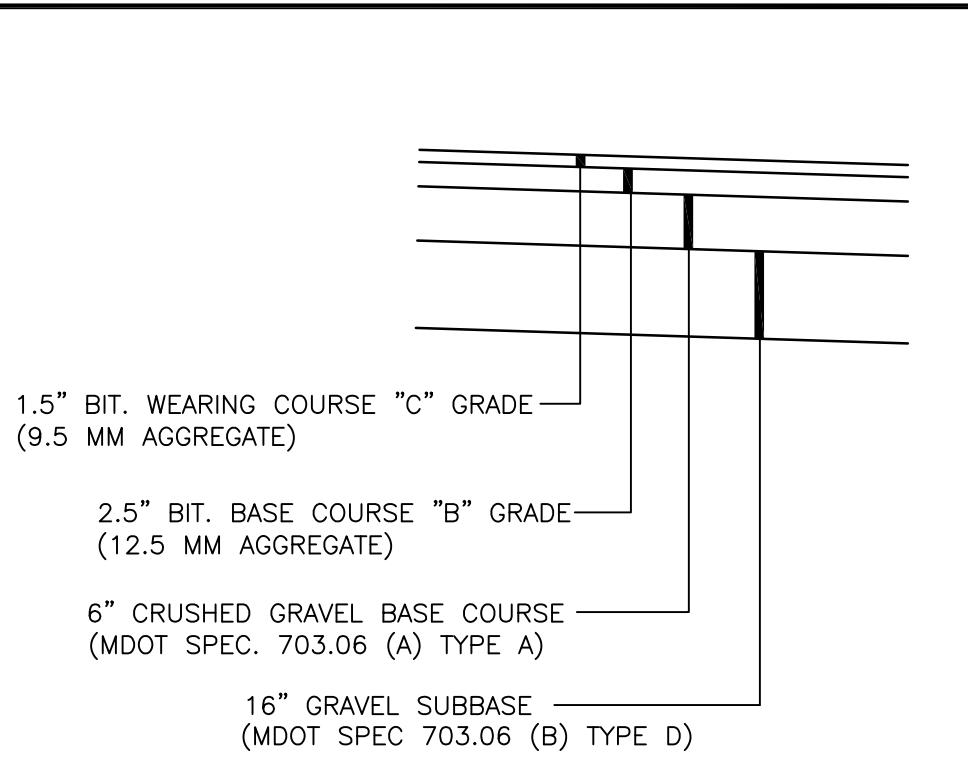


TYP. PAVEMENT SECTION
(FULL DEPTH CONSTRUCTION)

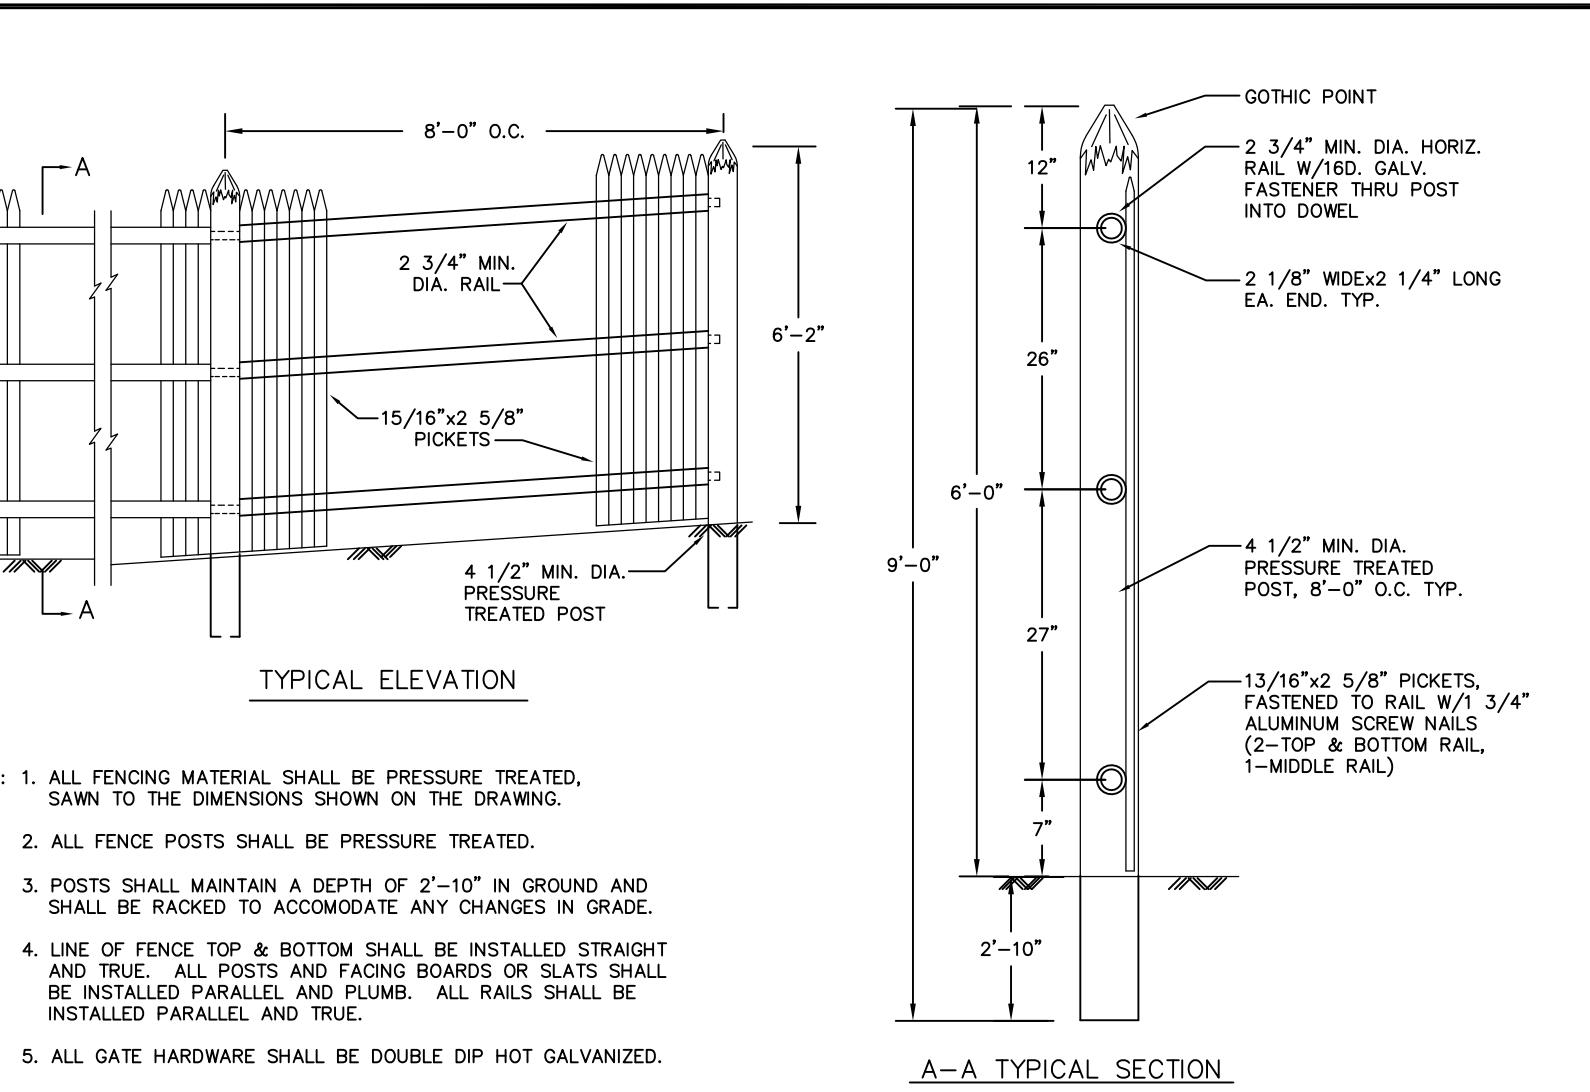

NOTES:


1. STAND OFF BRACKETS ARE REQUIRED WHEN MORE THAN ONE CONDUIT PER UTILITY IS TO BE INSTALLED ON A POLE.
2. ALL THREE PHASE PRIMARY RISERS, WHETHER STAND OFF BRACKETS ARE USED OR NOT, SHALL BE RIGID STEEL FOR THE FIRST SECTION.
3. ON SINGLE PHASE PRIMARY, SECONDARY AND SERVICE URD RISERS USING STAND OFF BRACKETS, RIGID STEEL OR SCHEDULE 80 MAY BE USED.
4. WHERE RIGID STEEL OR SCHEDULE 80 PVC IS USED FOR THE RISER, ONE BRACKET SHALL BE USED TO SUPPORT EACH SECTION OF CONDUIT UP TO 10 FEET IN LENGTH. EACH BRACKET IS TO BE PLACED JUST BELOW THE RISER CONDUIT COUPLING.
5. CONDUIT SECTIONS FOR A SINGLE PHASE OR THREE PHASE RISERS USING STAND OFF BRACKETS SHALL BE RIGID STEEL OR SCHEDULE 80 PVC CONDUIT ONLY (SEE NOTE #2), WITH THE EXCEPTION THAT SCHEDULE 40 PVC SUNLIGHT RESISTANT CONDUIT MAY BE USED FOR THE TOP SECTION OF THE RISER (NOT LONGER THAN 10'). IF TOP SECTION IS LONGER THAN 24" IT MUST BE SUPPORTED WITH A MINIMUM OF ONE STAND OFF BRACKET. IF TOP SECTION IS SCHEDULE 40 PVC AND LONGER THAN 72" IT MUST BE SUPPORTED BY NO FEWER THAN TWO STAND OFF BRACKETS.

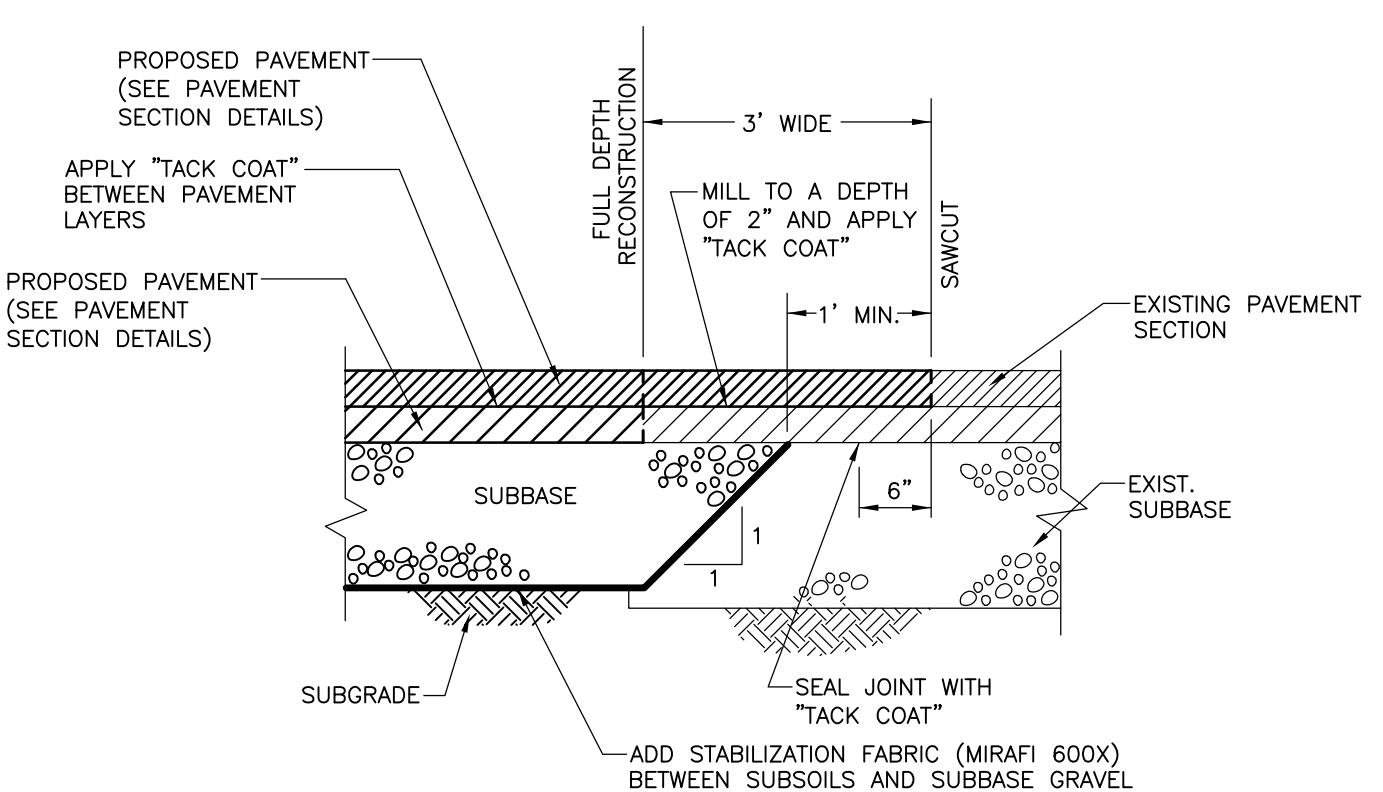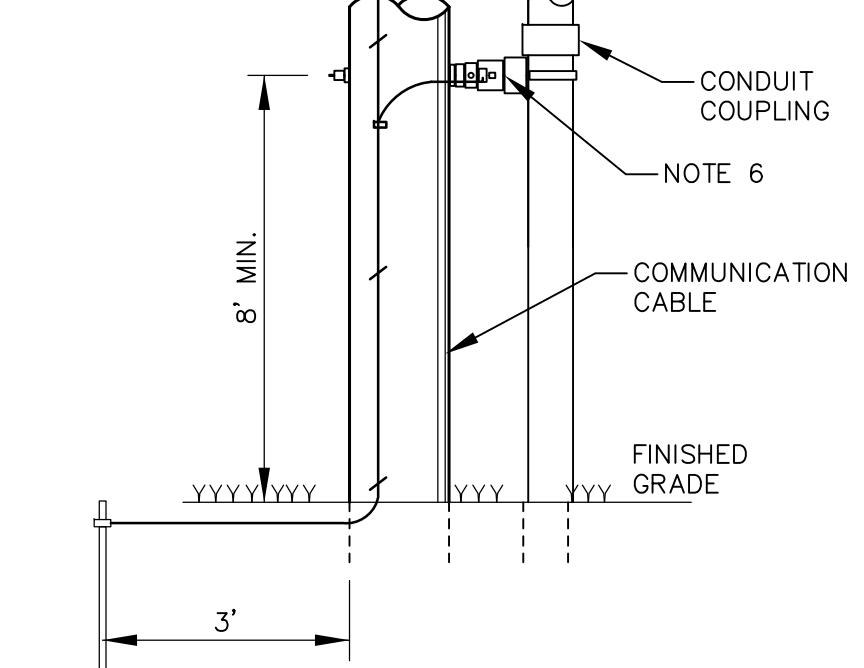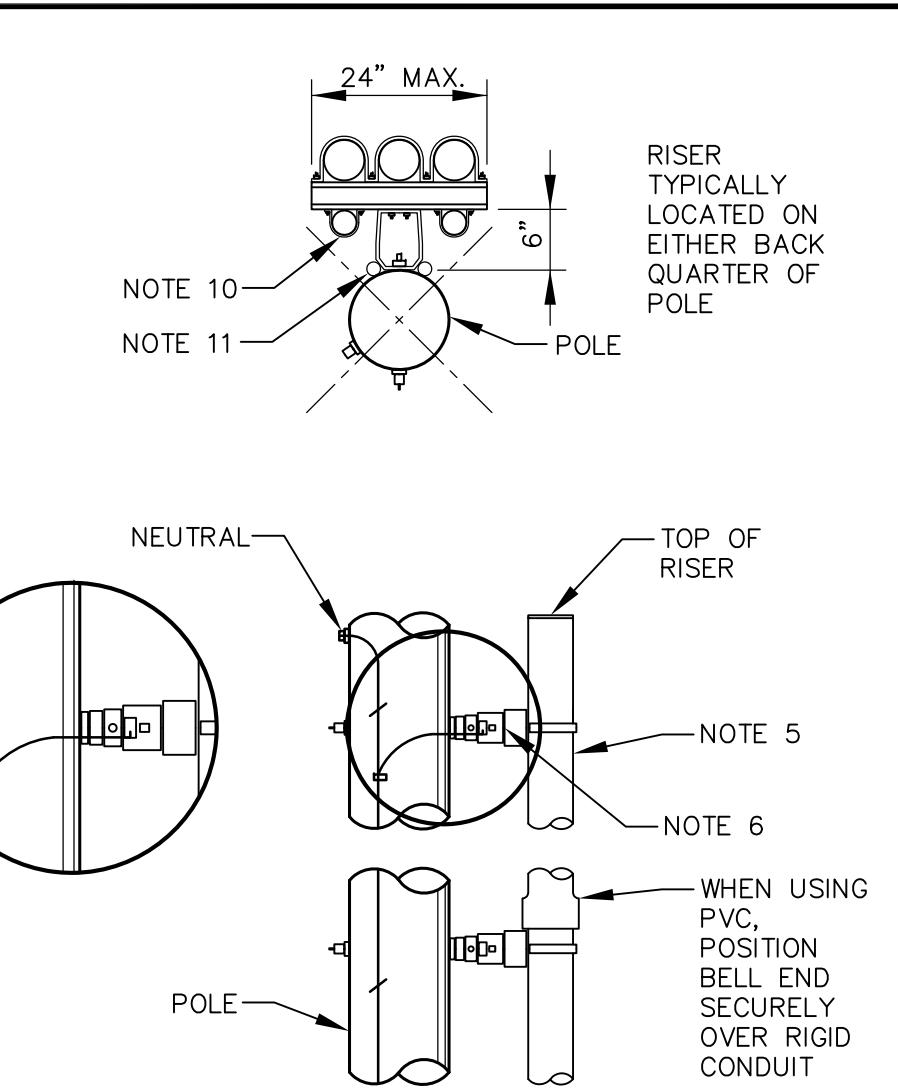


NOTE: PER MDOT ITEM 403

SAWCUT & PAVEMENT MATCH DETAIL


(AT DRIVEWAY ENTRANCE)

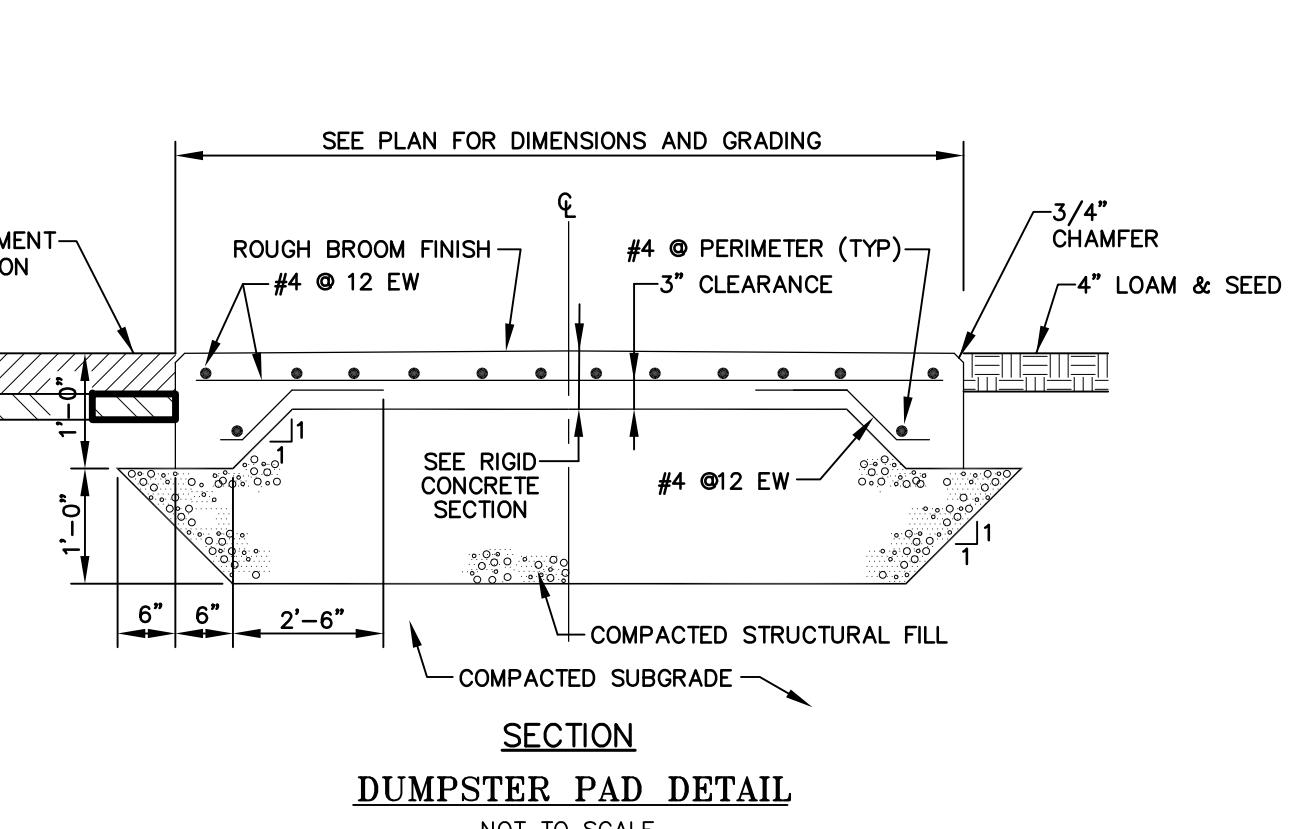


DUMPSTER PAD DETAIL
NOT TO SCALE

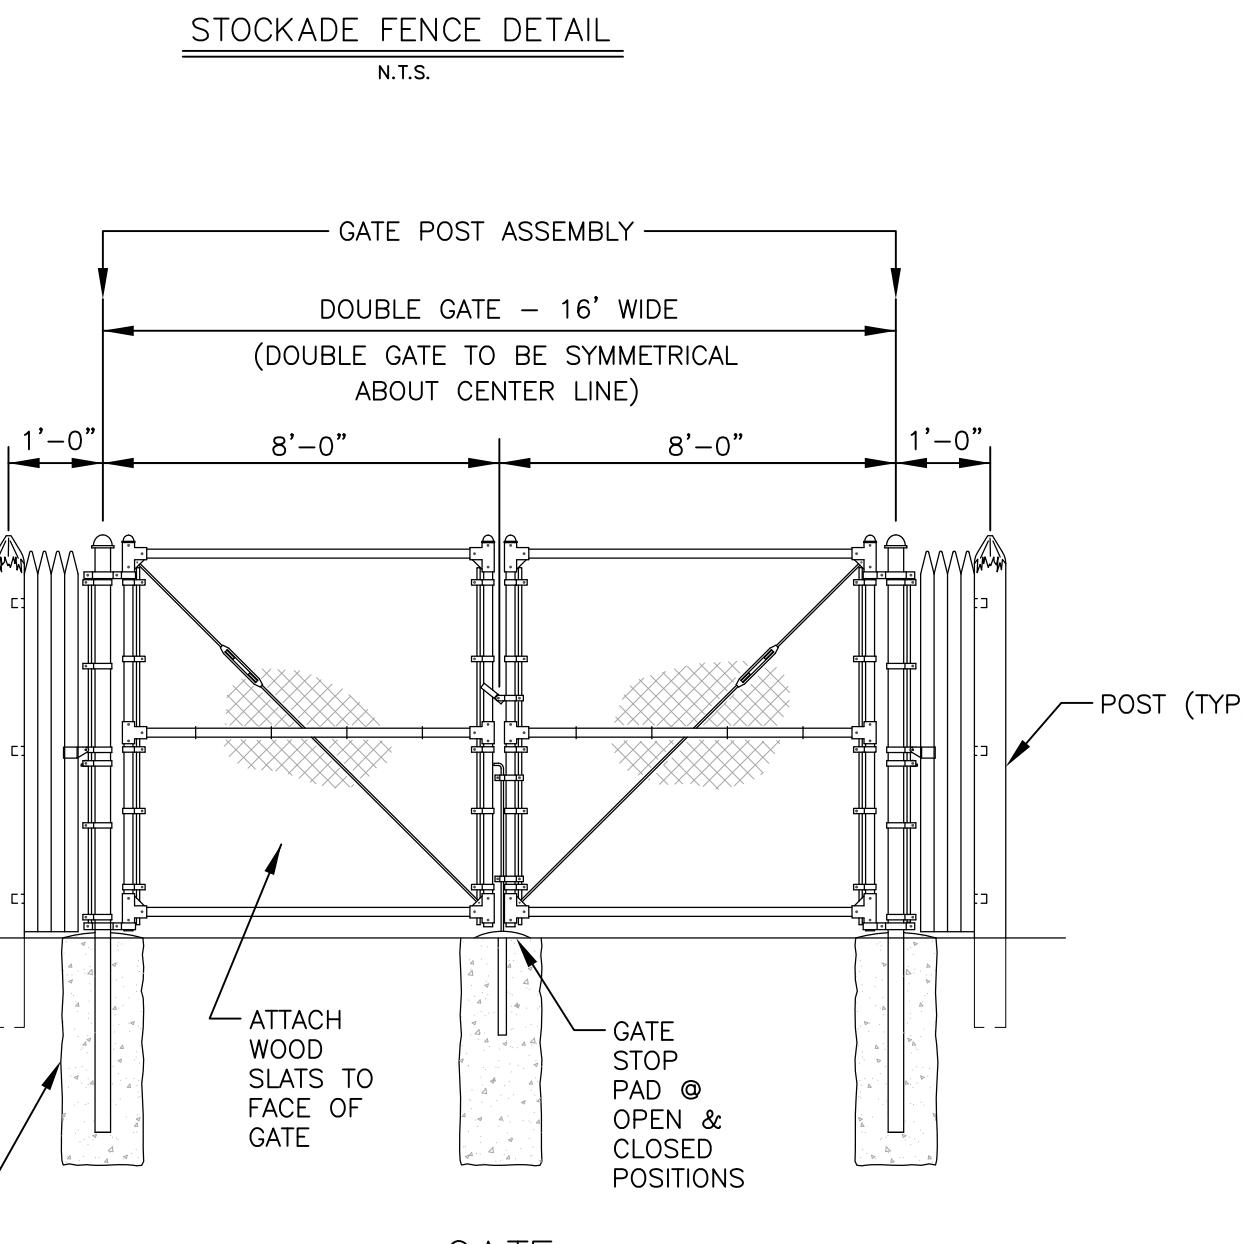


TYPICAL RISER DETAIL

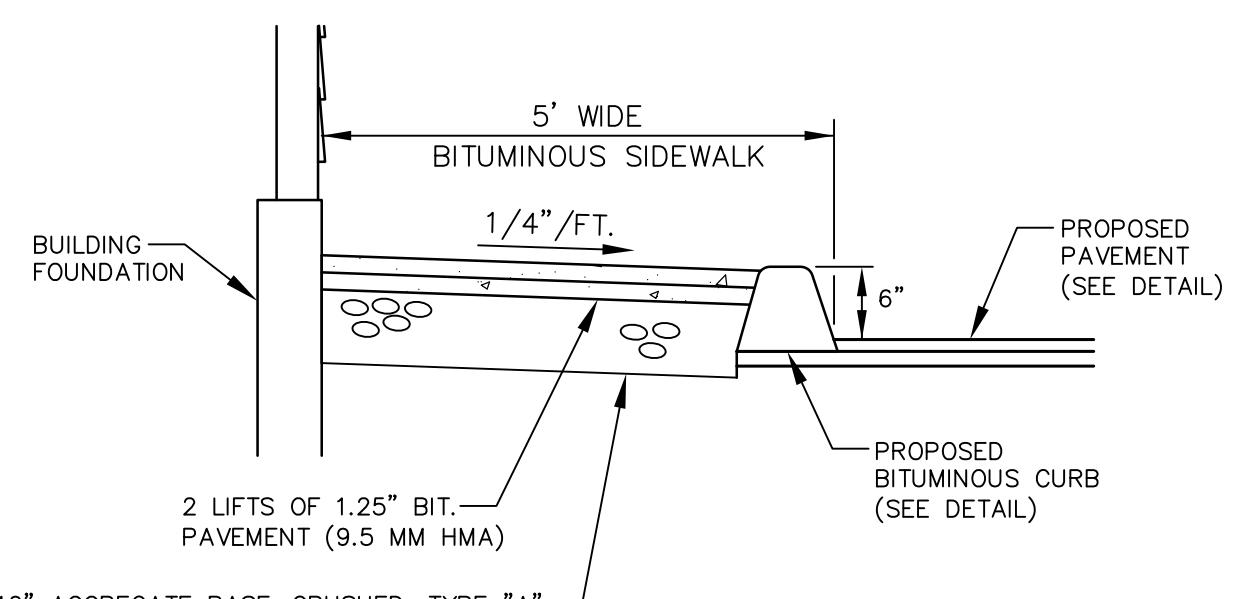


BITUMINOUS SIDEWALK DETAIL

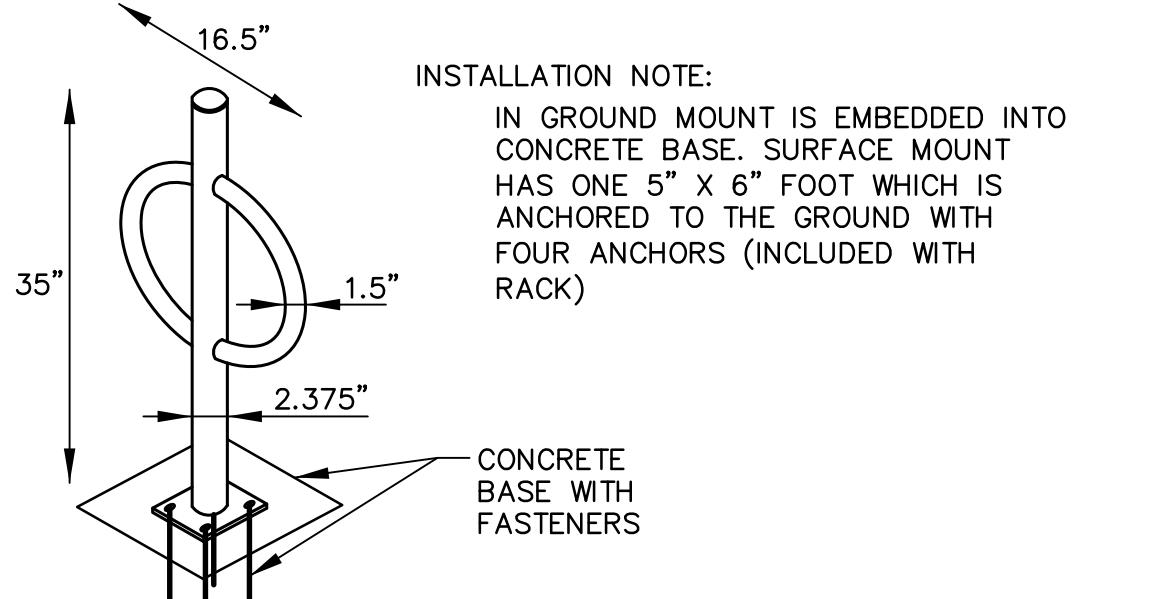

BIKE RACK DETAIL

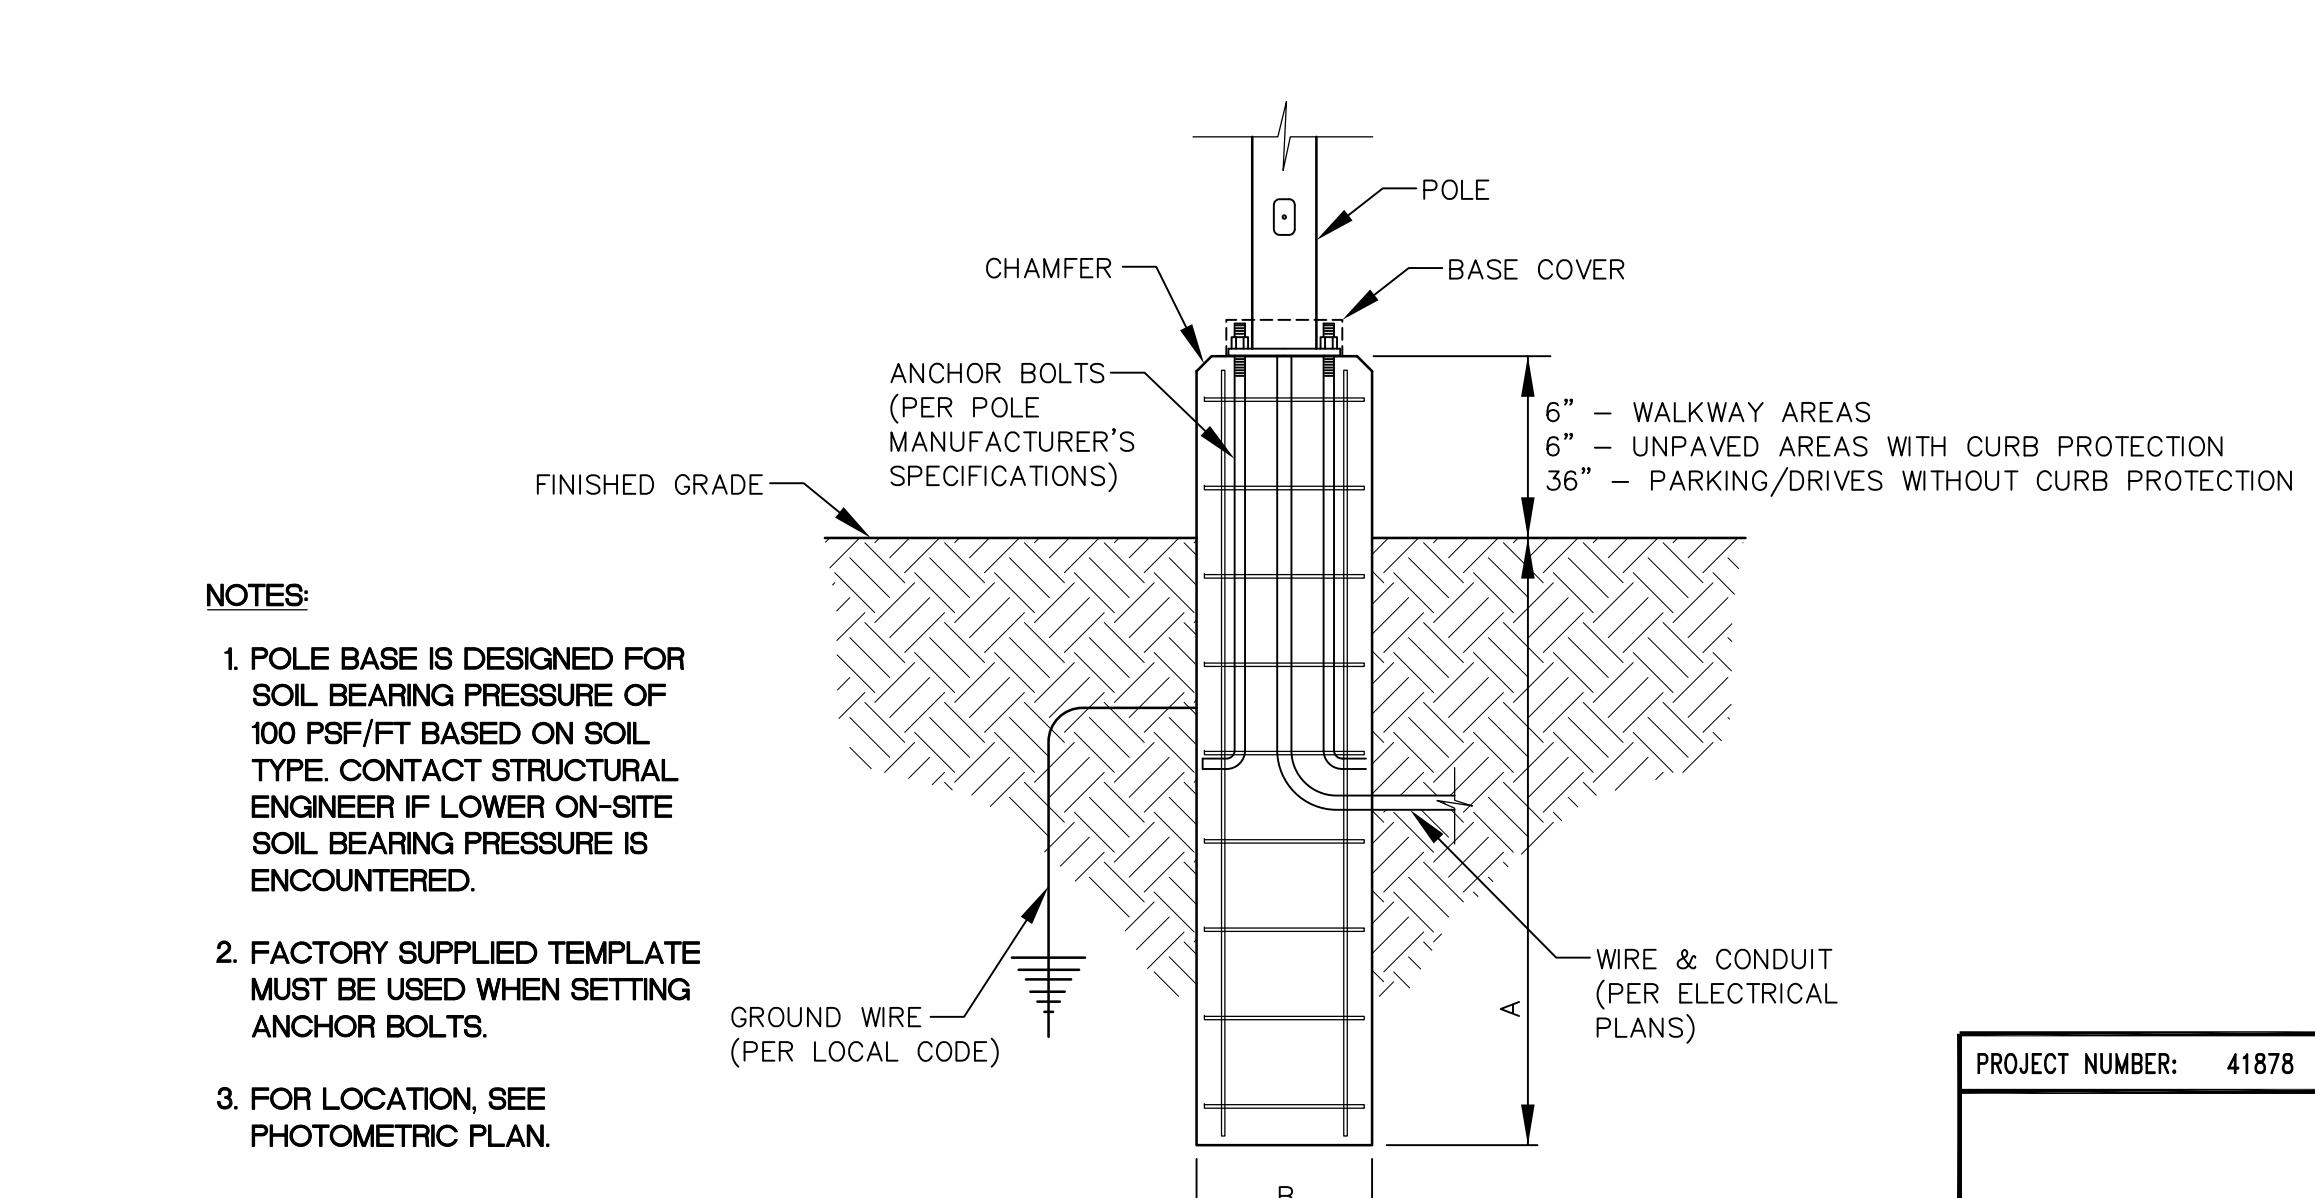



LIGHT POLE BASE

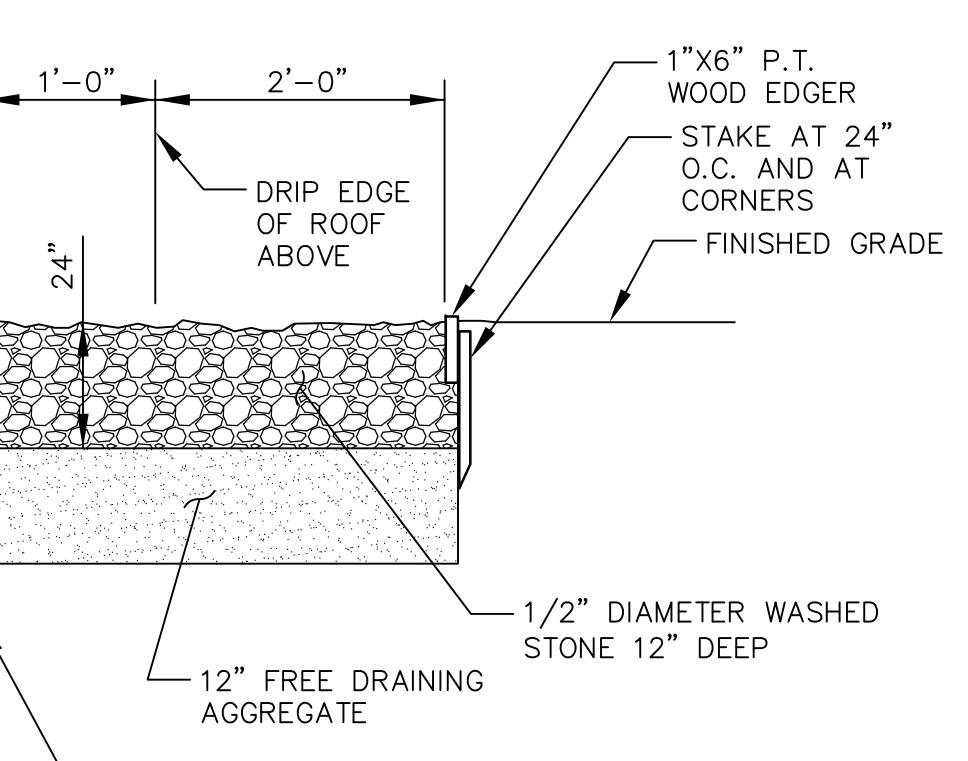

This technical diagram illustrates the cross-section of a sidewalk. At the top, a horizontal line is labeled 'BITUMINOUS SIDEWALK' with a width of '5 WIDE'. To the left, a vertical line is labeled '4" LOAM & SEED (SEE SITE PLAN)'. A horizontal arrow below the sidewalk line is labeled '1/4" /FT.'. The sidewalk itself is shown as a thick black line. Below the sidewalk, a cross-section reveals the construction layers: '2 LIFTS OF 1.25" BIT. PAVEMENT (9.5 MM HMA)' is at the bottom, followed by a thin layer, then a 'PROPOSED BITUMINOUS CURB (SEE DETAIL)' with a height of '6"'. A vertical line on the right is labeled 'PROPOSED PAVEMENT (SEE DETAIL)'.



STONE DRIP EDGE INFILTRATION DETAIL

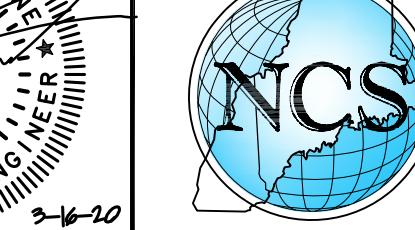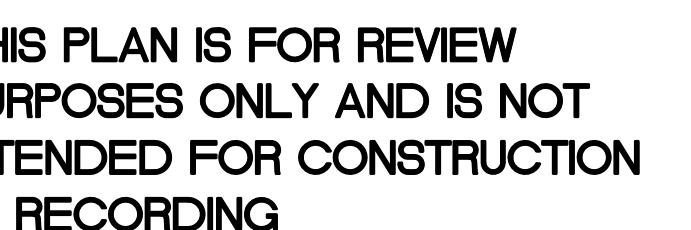



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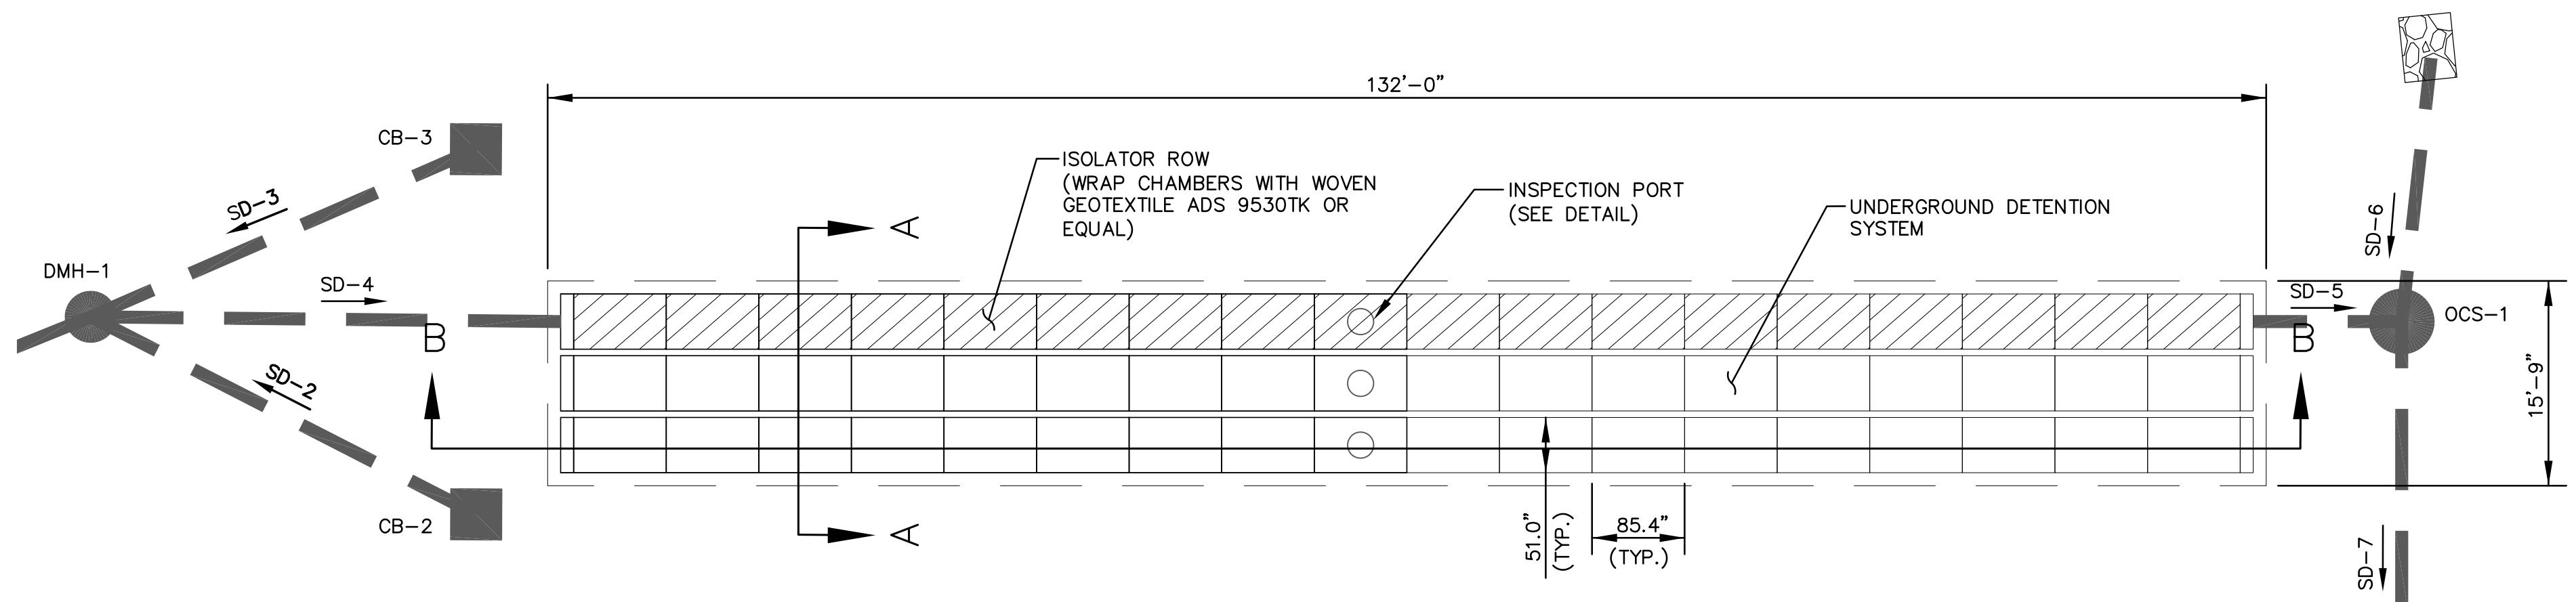
Northeast Civil Solutions

INCORPORATED

381 PAYNE ROAD, SCARBOROUGH, MAINE 04074

Revision:	By:	Date:	Change:
3	SMA	3/16/20	ADDED PROPANE TANKS
2	SMA	1/6/20	REVISED PER TOWN COMMENTS
1	SMA	12/21/20	SUBMITTED FOR TOWN REVIEW
OBJECT NUMBER: 41878	ACAD FILE: 41878-DETAILS.DWG		SCALE: AS NOTED
	DATE: DECEMBER 21, 2020		
	<p>Drawing Name:</p> <h2>CONSTRUCTION DETAILS - SHEET 1</h2>		
	<p>Project Name:</p> <h3>FIELDING CONDOS</h3> <p>ROOSEVELT TRAIL, WINDHAM, MAINE</p>		
	<p>Owner/Applicant:</p> <h3>FIELDING'S OIL CO., INC.</h3>		
	<p>SURVEYING • ENGINEERING • LAND PLANNING</p> <p><i>Northeast Civil Solutions</i> INCORPORATED</p> <p>381 PAYNE ROAD, SCARBOROUGH, MAINE 04074</p> <p>tel 207.883.1000 fax 207.883.1001 e-mail / website info@northeastcivilsolutions.com www.northeastcivilsolutions.com</p> 		

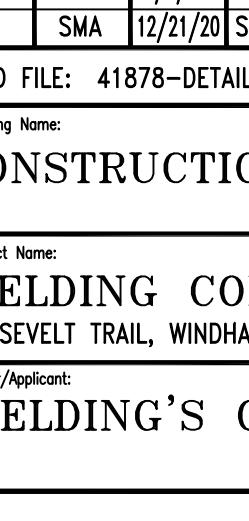

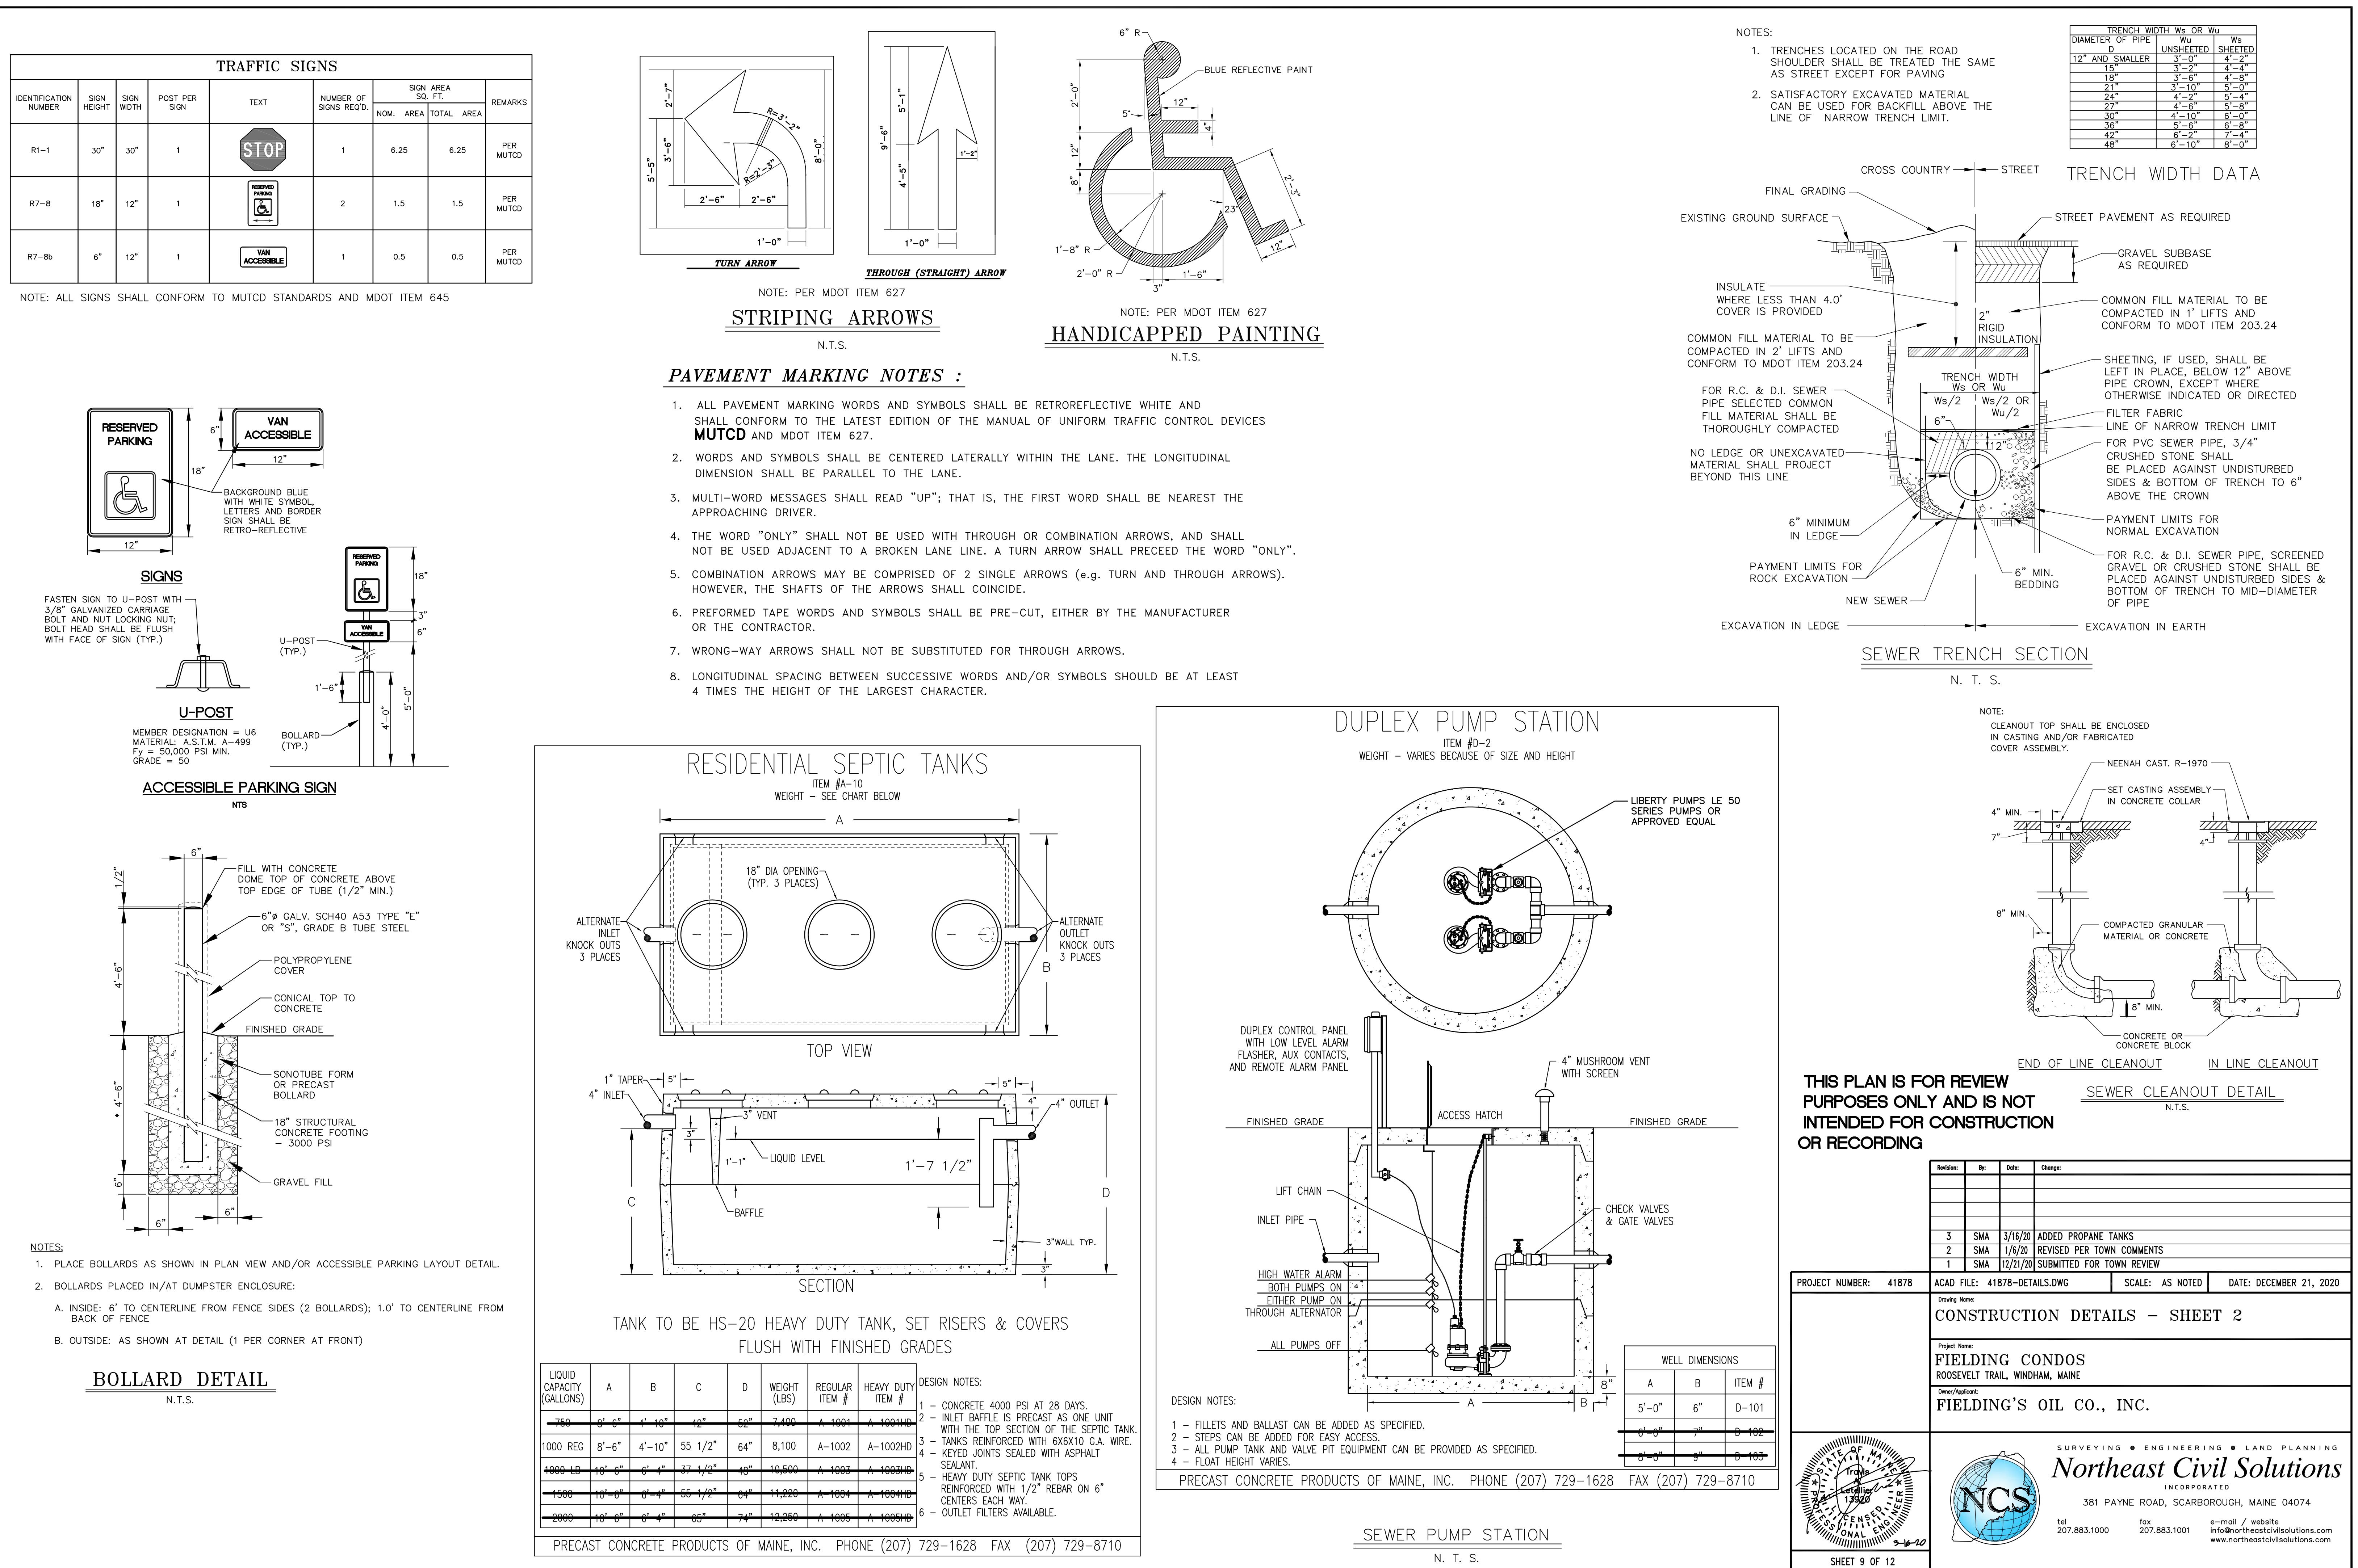

STORMWATER TREATMENT SYSTEM

SCALE: 1" = 10'

TABLE 7-3 SAND FILTER MEDIA	
SIEVE SIZE	% BY WEIGHT
3/8"	100
#4	95-100
#8	80-100
#16	50-85
#30	25-60
#60	10-30
#100	2-10
#200	0-5 (8-10% IS PREFERRED)

MAINE DOT SPECIFICATION
AGGREGATE MDOT #703.01


TABLE 7-1 ME DOT SPECIFICATIONS FOR UNDERDRAINS (ME DOT #703.22)	
SIEVE SIZE	% BY WEIGHT
1"	90-100
1/2"	75-100
#4	50-100
#20	15-80
#50	0-15
#200	0-5

UNDERDRAIN TYPE C	
1"	100
3/4"	90-100
3/8"	0-75
#4	0-25
#10	0-5

TYPE B COARSE GRAVEL SHALL
HAVE NO MORE THAN 5%
(PREFERABLY 2%) OF FINES
PASSING THE #200 SIEVE


SAND FILTER SPECIFICATIONS:

1. SAND MATERIAL TO HAVE UNIFORM MIX, FREE OF STONES, STUMPS, ROOTS OR OTHER OBJECTS LARGER THAN 2".
2. FILTER MEDIA SHALL CONSIST OF SILT/SAND LAYER WITH A FINES CONTENT OF 8% BUT NOT GREATER THAN 10% (I.E. 8%-10% PASSING #200 SIEVE)
3. DO NOT OVER COMPACT SAND MEDIA. PERMEABILITY OF FILTER WILL DECREASE IF OVER COMPACTED. ANTICIPATED LEVEL OF COMPACTION IS EQUAL TO 90-92% STANDARD PROCTOR.
4. MEDIA SHALL HAVE FILTRATION VELOCITY BETWEEN 2.5 AND 4.75 IN/HR SUCH THAT THE SYSTEM WILL DRAIN WITHIN 24-48 HOURS.

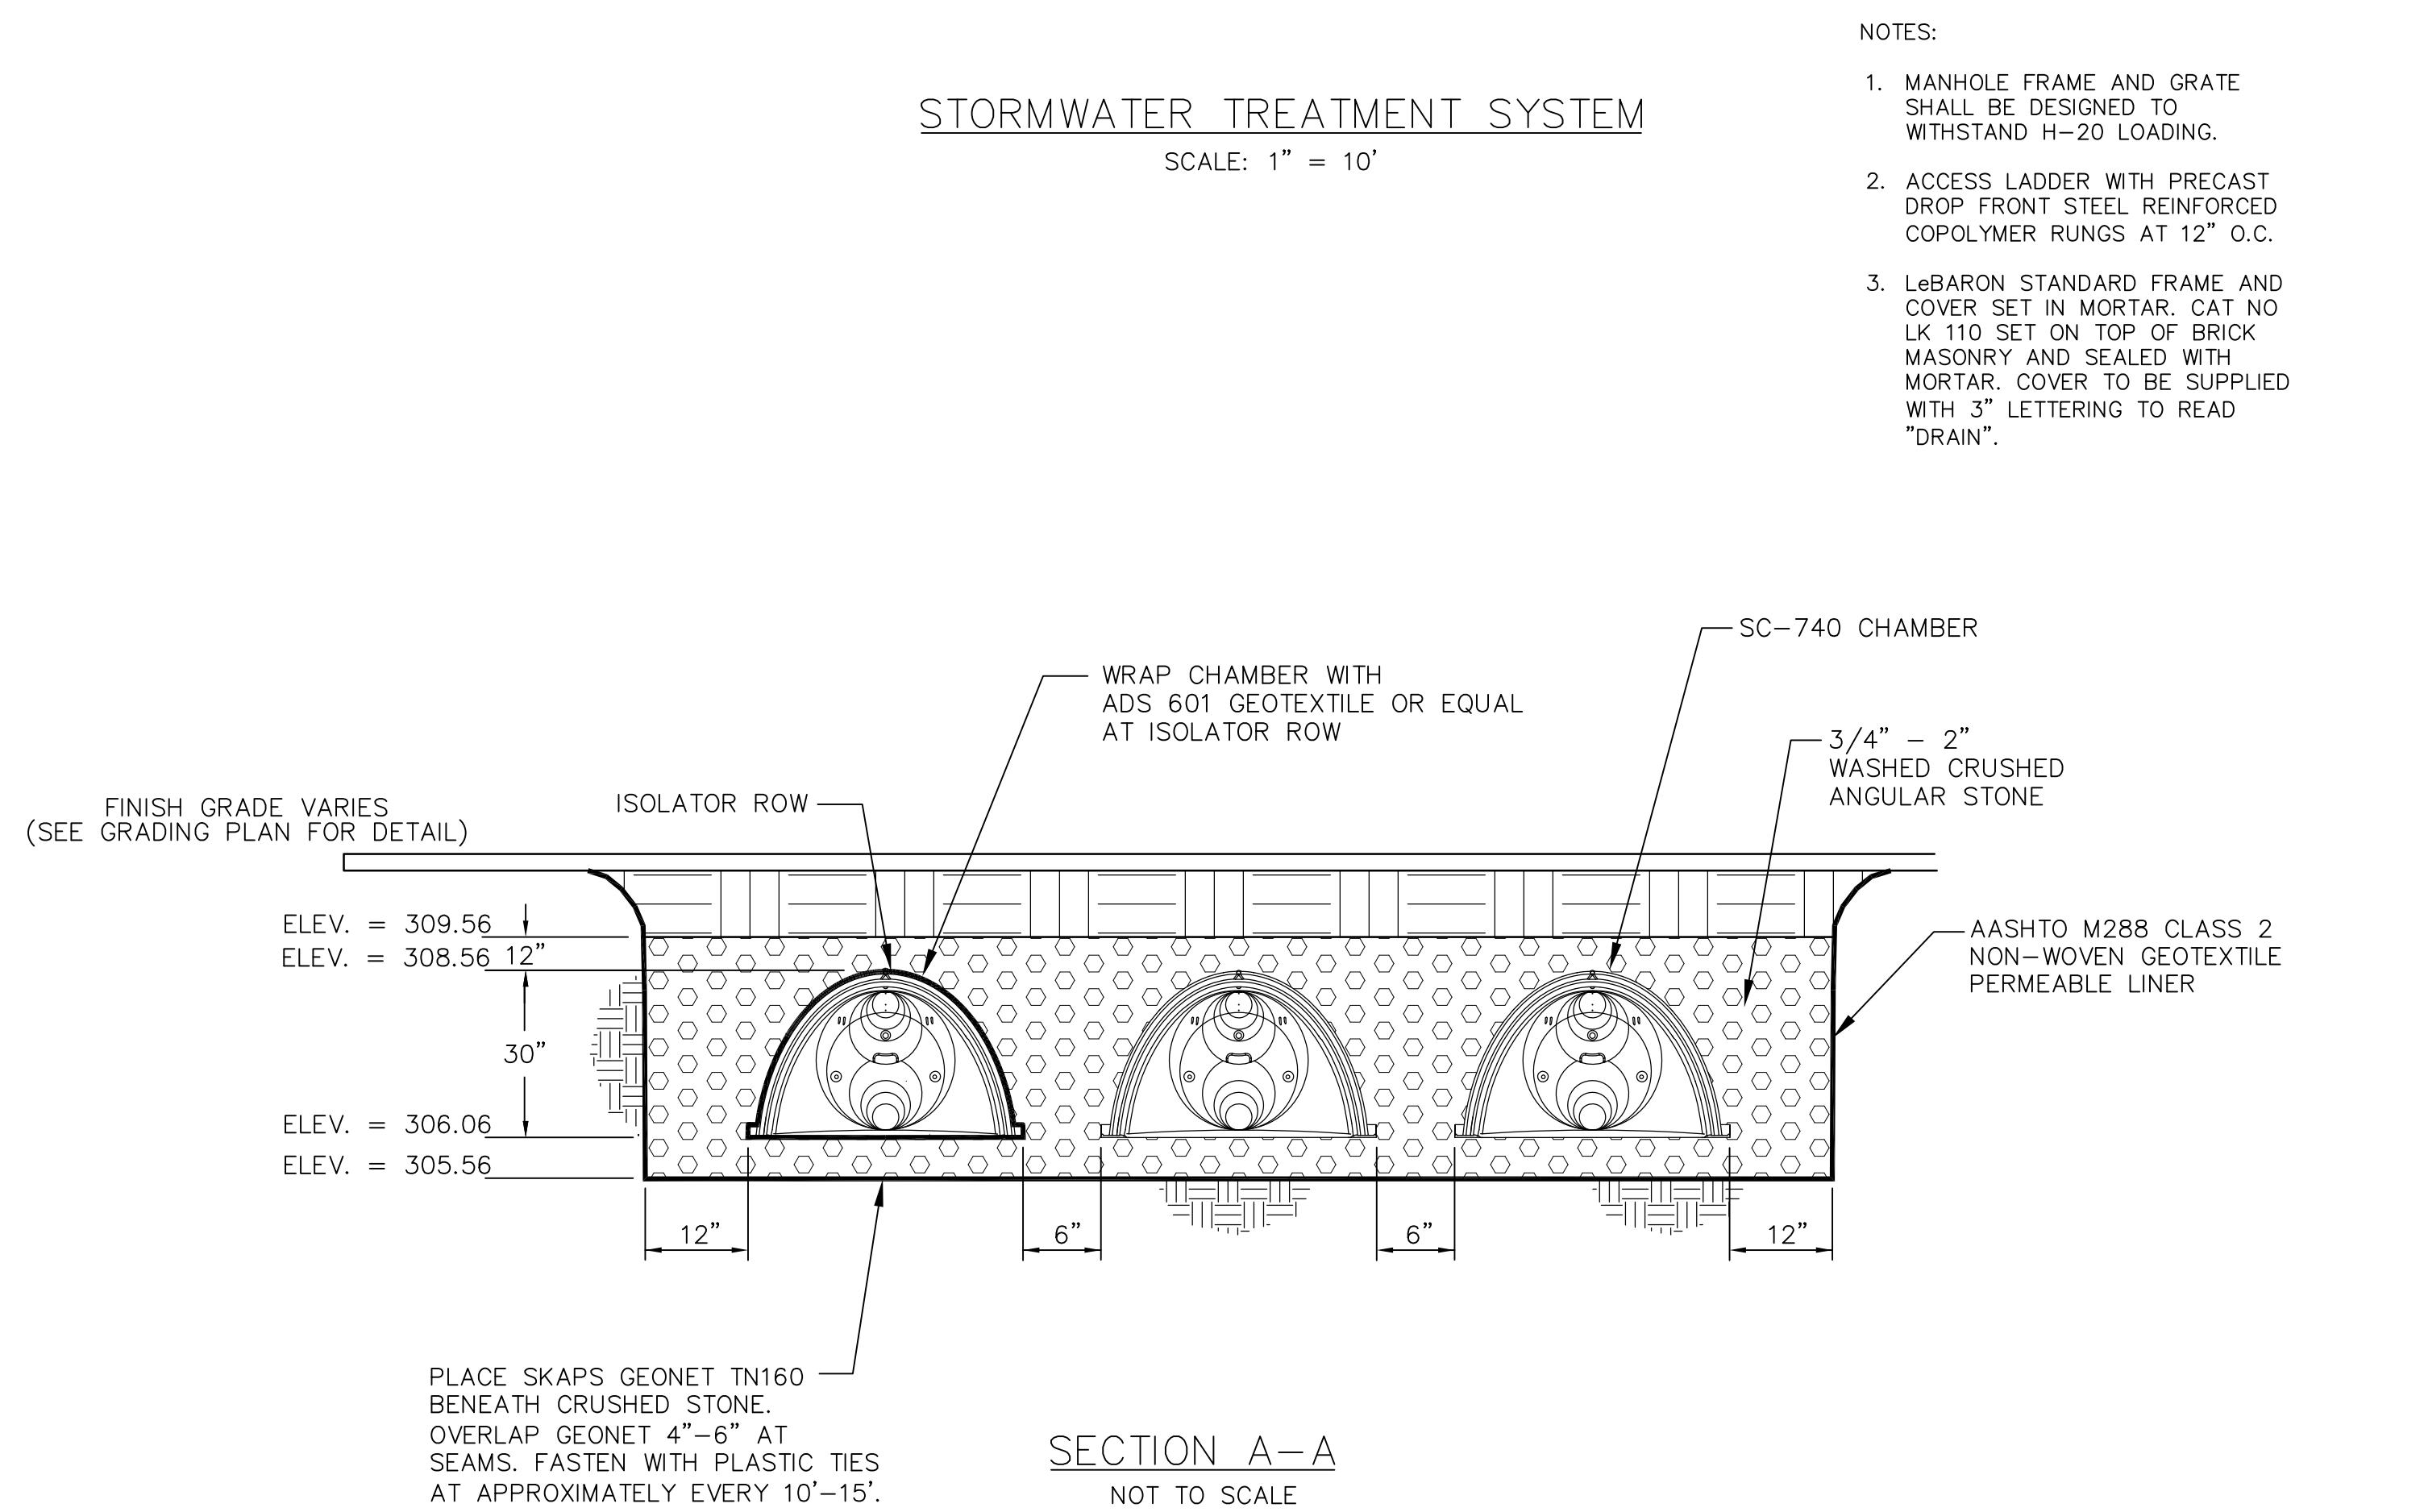


SECTION A-A

NOT TO SCALE

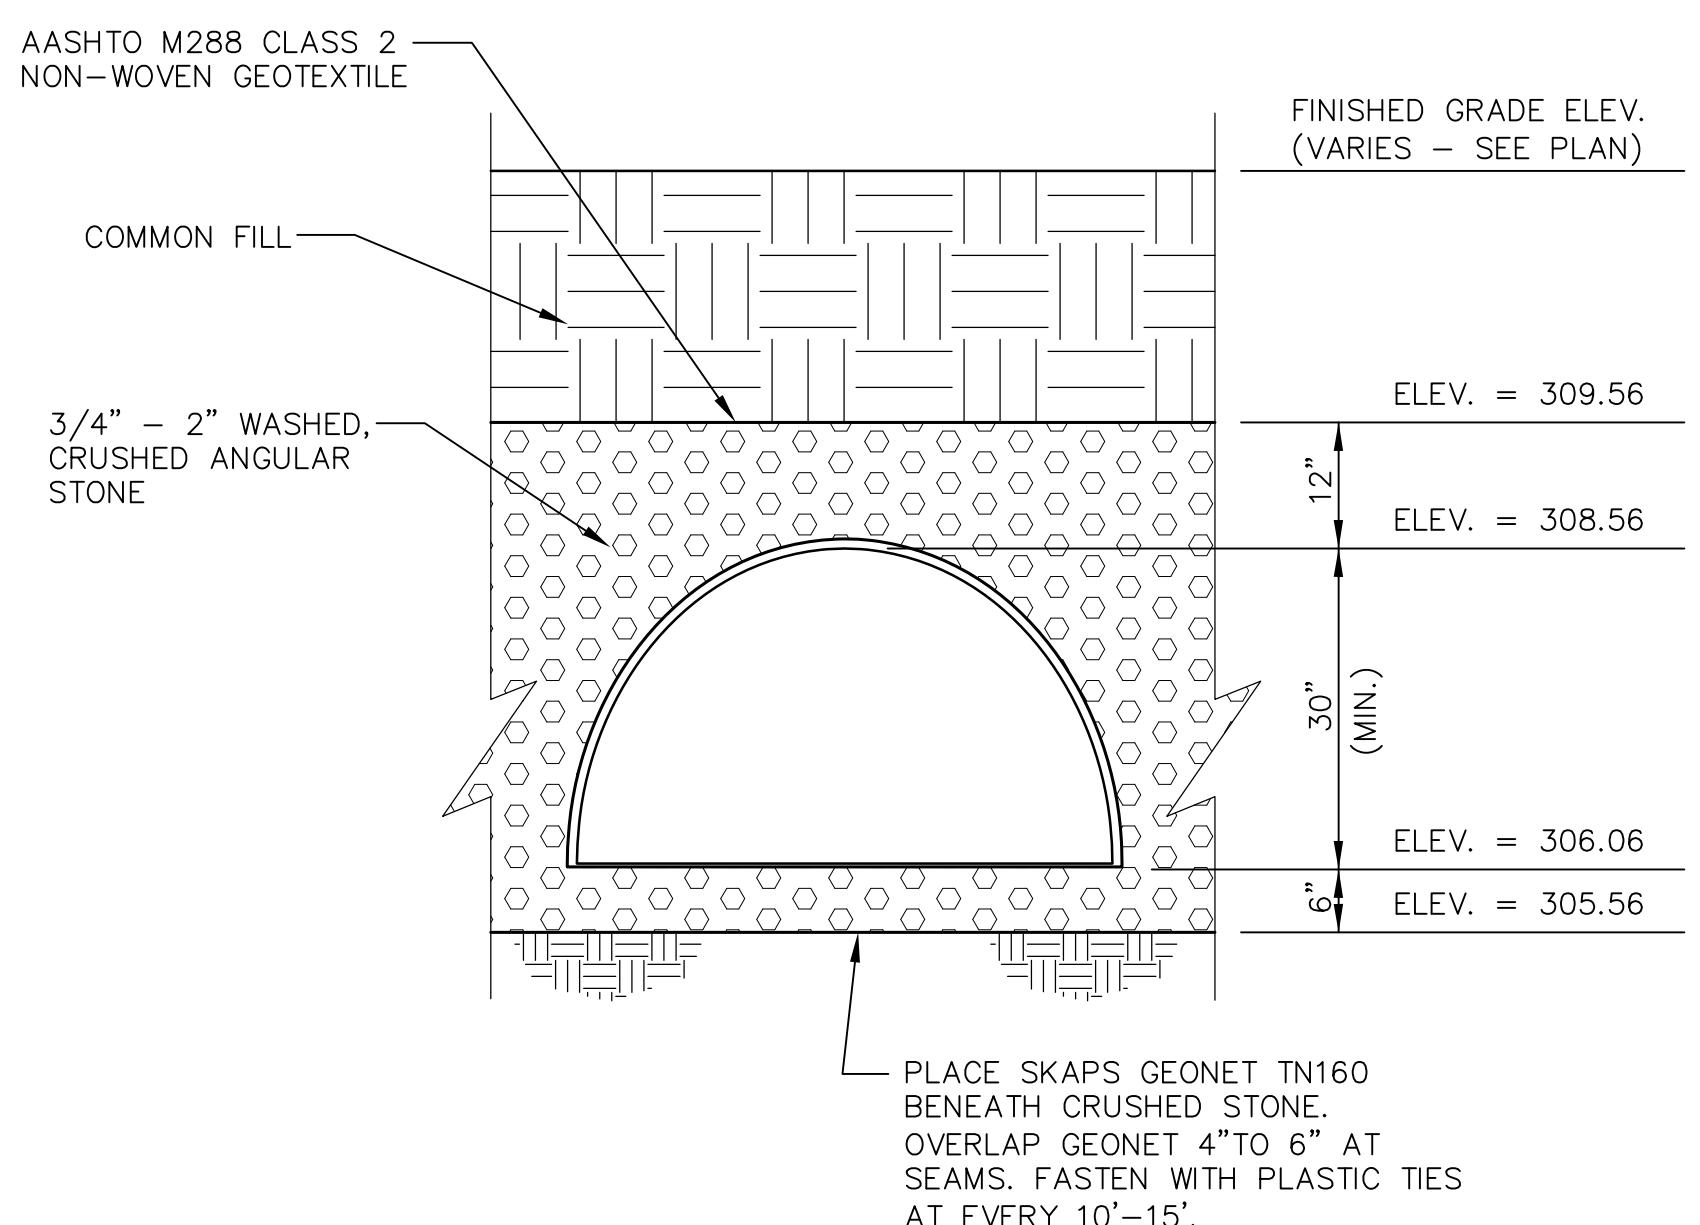


UNDERGROUND DETENTION CROSS SECTION
NOT TO SCALE


THIS PLAN IS FOR REVIEW
PURPOSES ONLY AND IS NOT
INTENDED FOR CONSTRUCTION
OR RECORDING

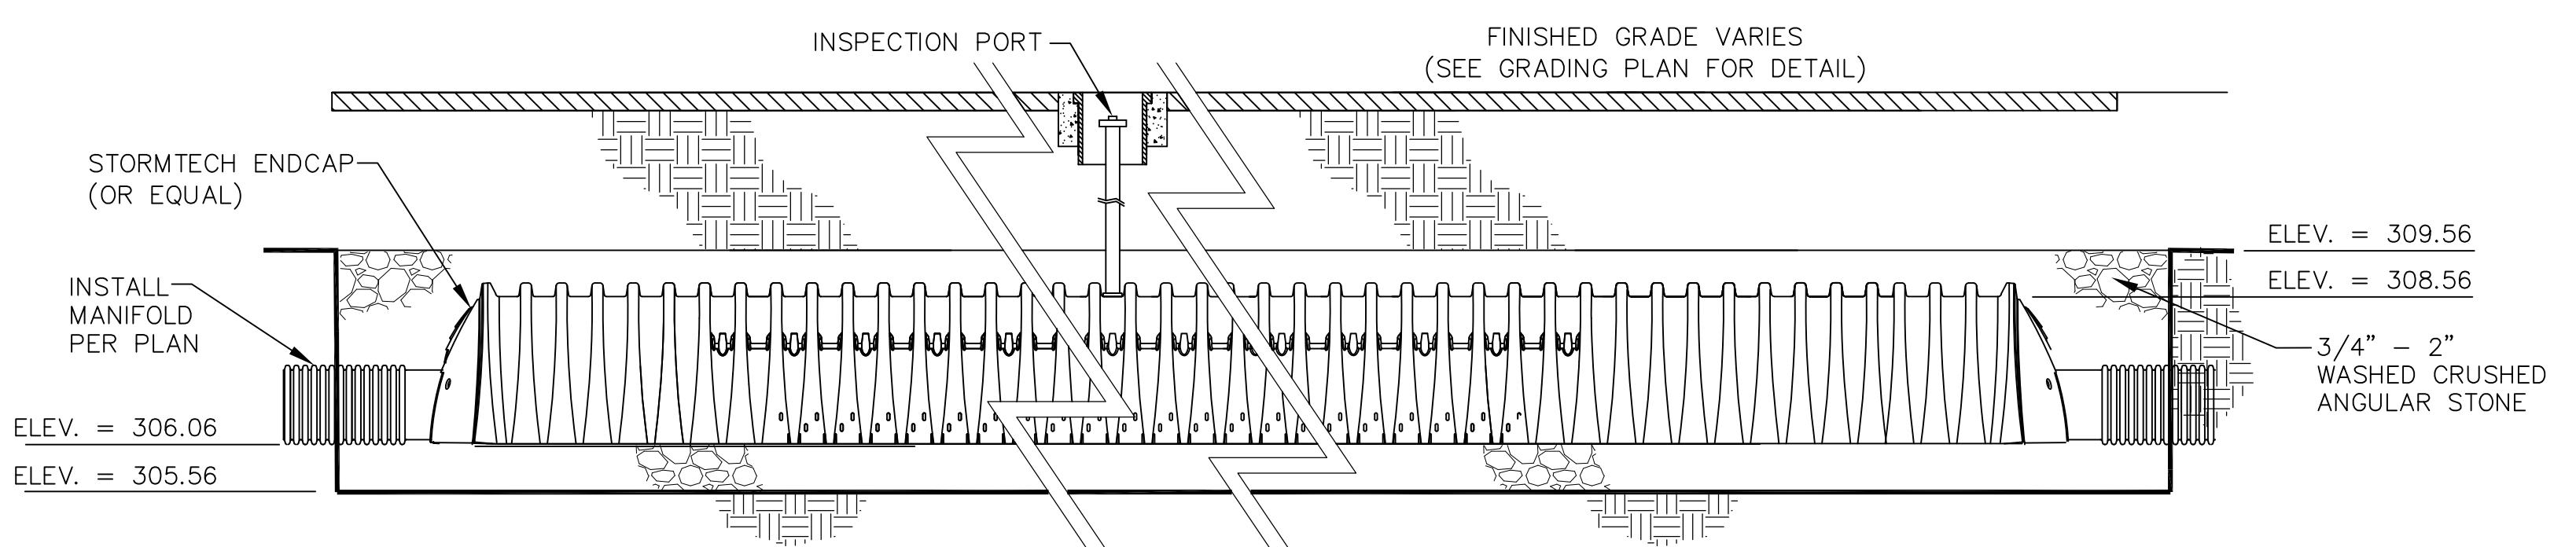

SECTION B-B

NOT TO SCALE

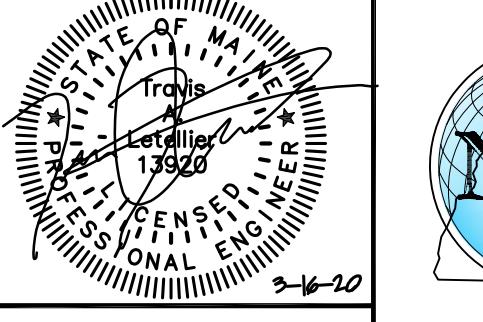Revision:	By:	Date:	Change:
3	SMA	3/16/20	ADDED PROPANE TANKS
2	SMA	1/6/20	REVISED PER TOWN COMMENTS
1	SMA	12/21/20	SUBMITTED FOR TOWN REVIEW
PROJECT NUMBER: 41878			
ACAD FILE: 41878-UG-DET.DWG			
SCALE: AS NOTED			
DATE: DECEMBER 21, 2020			
Drawing Name: UNDERGROUND DETENTION DETAILS - SHEET 1			
Project Name: FIELDING CONDOS ROOSEVELT TRAIL, WINDHAM, MAINE			
Owner/Acquirer: FIELDING'S OIL CO., INC.			
 <p>SURVEYING • ENGINEERING • LAND PLANNING Northeast Civil Solutions INCORPORATED 381 PAYNE ROAD, SCARBOROUGH, MAINE 04074 tel 207.883.1000 fax 207.883.1001 e-mail info@northeastcivilsolutions.com www.northeastcivilsolutions.com</p>			
SHEET 11 OF 12			

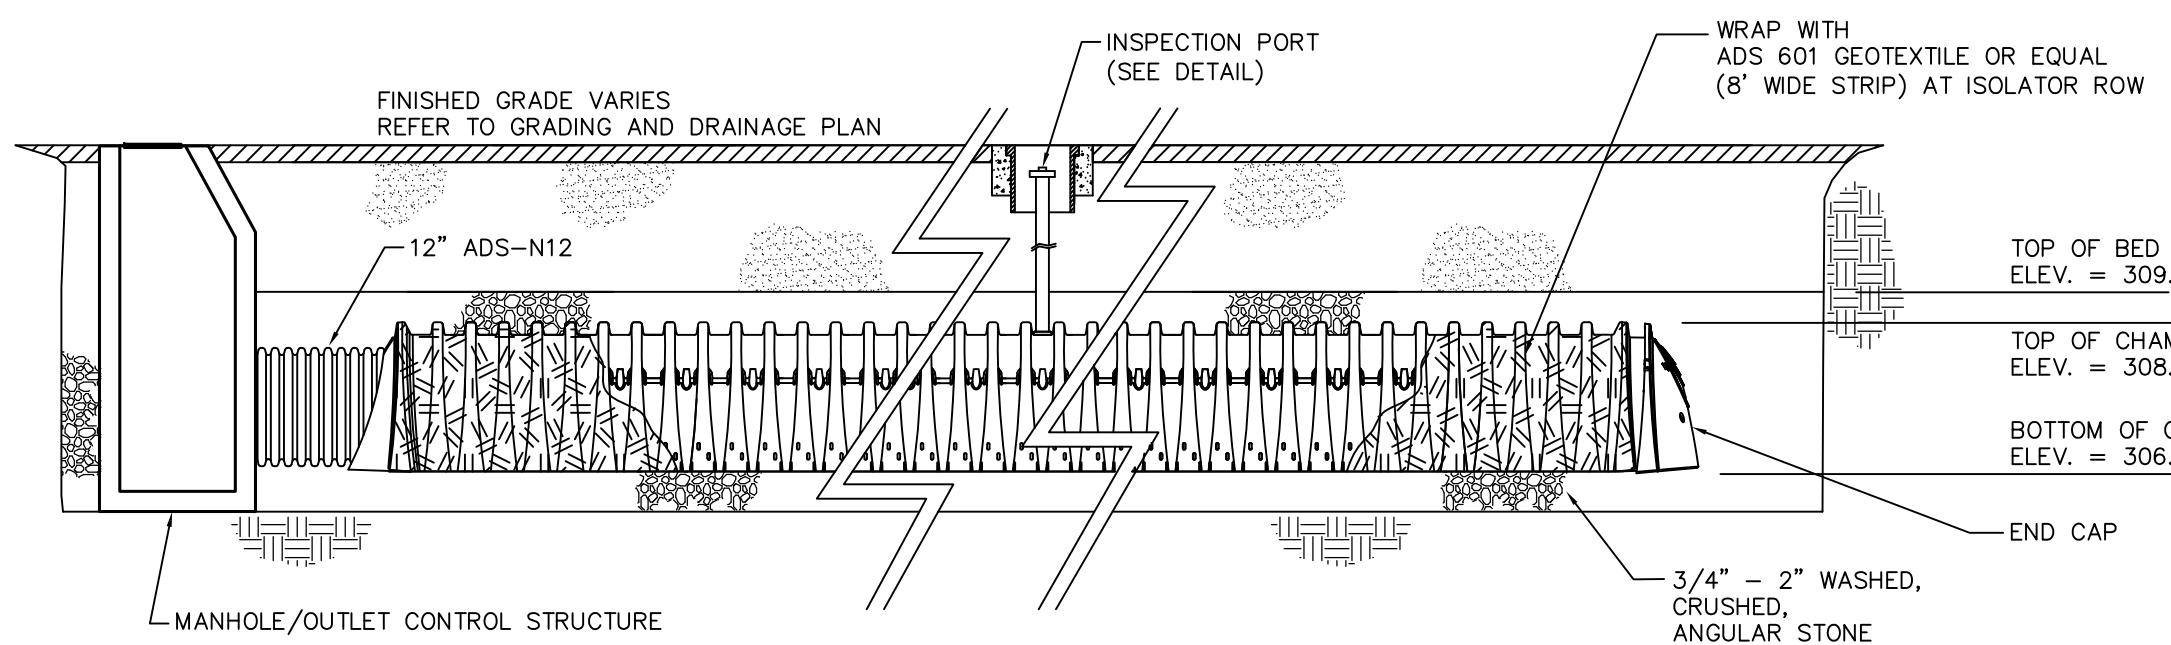


ISOLATOR ROW DETAIL

NOT TO SCALE

NOTES:

1. ALL DESIGN SPECIFICATIONS FOR STORMTECH CHAMBERS SHALL BE IN ACCORDANCE WITH THE STORMTECH DESIGN MANUAL.
2. THE INSTALLATION OF STORMTECH CHAMBERS SHALL BE IN ACCORDANCE WITH THE LATEST STORMTECH INSTALLATION INSTRUCTIONS.
3. THE CONTRACTOR IS ADVISED TO REVIEW AND UNDERSTAND THE INSTALLATION INSTRUCTIONS PRIOR TO BEGINNING SYSTEM INSTALLATION. CALL 1-888-892-2694 OR VISIT WWW.STORMTECH.COM TO RECEIVE A COPY OF THE LATEST STORMTECH INSTALLATION INSTRUCTIONS.

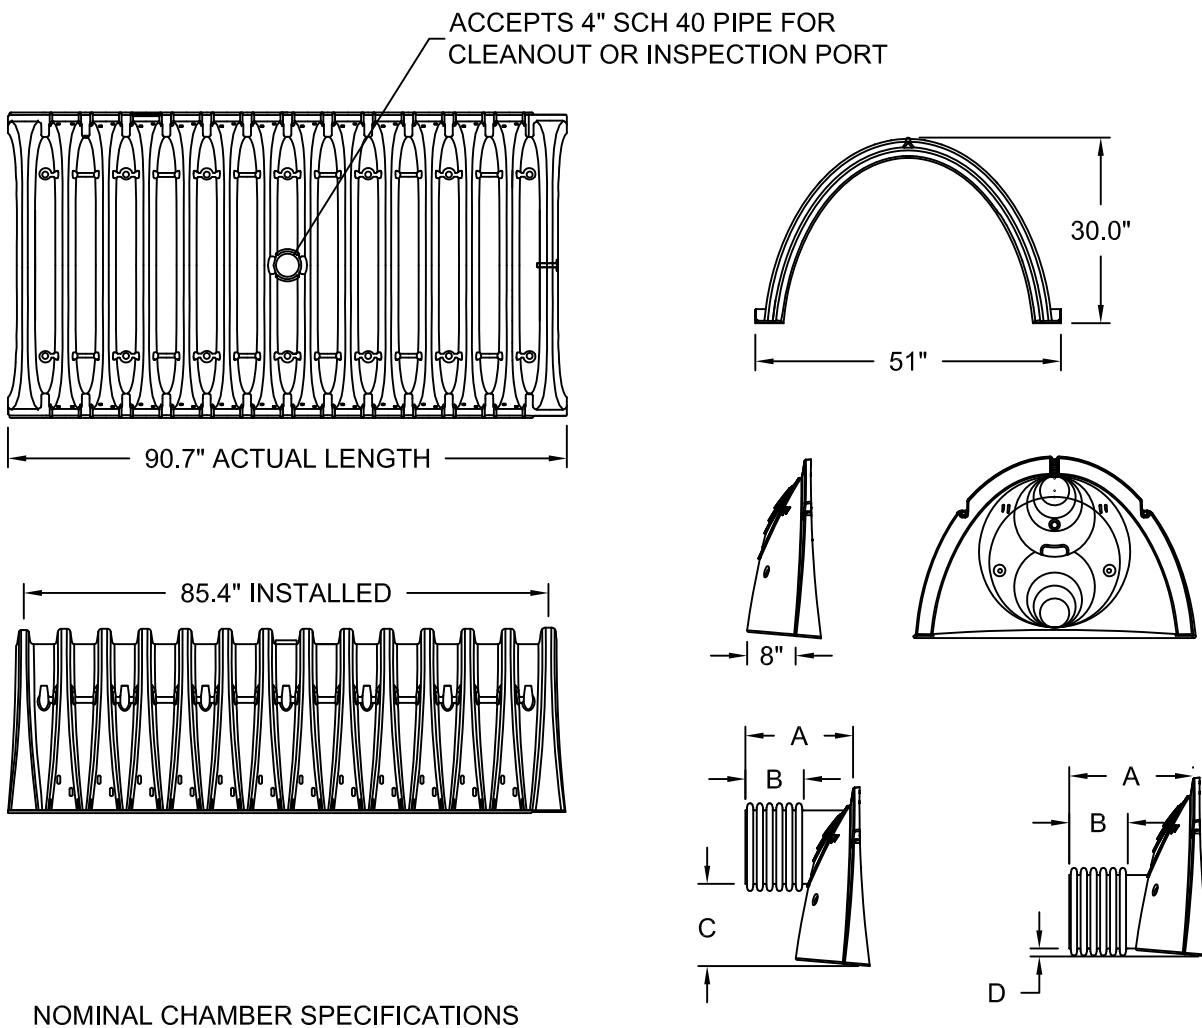

ACCEPTABLE FILL MATERIALS STORMTECH SC-740 CHAMBER SYSTEMS

MATERIAL LOCATION	DESCRIPTION	AASHTO M43 DESIGNATION	AASHTO M145 DESIGNATION	COMPACTION/DENSITY REQUIREMENT
FILL MATERIAL FROM 18" TO GRADE ABOVE CHAMBERS	ANY SOIL/ROCK MATERIALS, NATIVE SOILS OR PER ENGINEER'S PLANS. (SEE TYPICAL STORMWATER TRENCH SECTION ON SHEET C-10)	N/A	N/A	PREPARE PER ENGINEER'S PLANS. PAVED INSTALLATIONS MAY HAVE STRINGENT MATERIAL AND PREPARATION REQUIREMENTS.
FILL MATERIAL FOR 6" TO 18" ELEVATION ABOVE CHAMBERS (24" FOR UNPAVED INSTALLATIONS)	GRANULAR WELL-GRADED SOIL/AGGREGATE MIXTURES, <35% FINES.	3, 357, 4, 467, 5, 56, 57, 6, 67, 68, 7, 78, 8, 89, 9, 10	A-1 A-2 A-3	COMPACT IN 6" LIFTS TO A MINIMUM 95% STANDARD PROCTOR DENSITY. ROLL GROSS VEHICLE WEIGHT NOT TO EXCEED 12,000 LBS. DYNAMIC FORCE NOT TO EXCEED 20,000 LBS.
EMBEDMENT STONE SURROUNDING TO AN ELEVATION 12" ABOVE & 6" BELOW CHAMBERS	WASHED ANGULAR STONE WITH THE MAJORITY OF PARTICLES BETWEEN $\frac{1}{2}$ & 2 INCH	3, 357, 4, 467, 5, 56, 57	N/A	NO COMPACTION REQUIRED
FOUNDATION BELOW CHAMBERS	WASHED ANGULAR STONE WITH THE MAJORITY OF PARTICLES BETWEEN $\frac{1}{2}$ & 2 INCH	3, 357, 4, 467, 5, 56, 57	N/A	PLATE COMPACT OR ROLL TO ACHIEVE A 95% STANDARD PROCTOR DENSITY
SUBSURFACE SOIL FILTER	SEE CROSS SECTION	N/A	N/A	

STORMTECH ACCEPTABLE FILL MATERIALS

NOMINAL CHAMBER SPECIFICATIONS
SIZE (W x H x INSTALLED LENGTH)
CHAMBER STORAGE
MINIMUM INSTALLED STORAGE
WEIGHT

51.0" x 30.0" x 85.4"
45.9 CUBIC FEET
74.9 CUBIC FEET
75 LBS.


STUBS AT TOP OF END CAP FOR PARTS NUMBERS ENDING WITH "1"
STUBS AT BOTTOM OF END CAP FOR PARTS NUMBERS ENDING WITH "B"

PART #	CHAMBER	PIPE SIZE	A	B	C	D
SC740EP12B	SC-740	12 in (300 mm)	14.70 in (373 mm)	7.70 in (196 mm)	N/A	1.20 in (30 mm)
SC740EP24B	SC-740	24 in (600 mm)	18.50 in (470 mm)	9.45 in (240 mm)	N/A	0.10 in (3 mm)

NOTE: ALL DIMENSIONS ARE NOMINAL
ALL STUBS, EXCEPT FOR THE STUB AT THE TOP OF THE END CAP, ARE AT THE BOTTOM OF END CAP SUCH THAT THE OUTSIDE DIAMETER OF THE STUB IS FULL WIDTH OF THE END CAP. THE END CAP SHOULD BE REMOVED FROM BELOW THE N-12 STUB SO THAT THE FITTING SETS LEVEL.
* FOR THE SC740EP24B THE 24" STUB LIES APPROXIMATELY 1.75" BELOW THE BOTTOM OF THE END CAP. BACKFILL MATERIAL SHOULD BE REMOVED FROM BELOW THE N-12 STUB FOR ADDITIONAL INFORMATION CONTACT STORMTECH AT 1-888-892-2694.

SC-740 TECHNICAL DETAILS

NOT TO SCALE

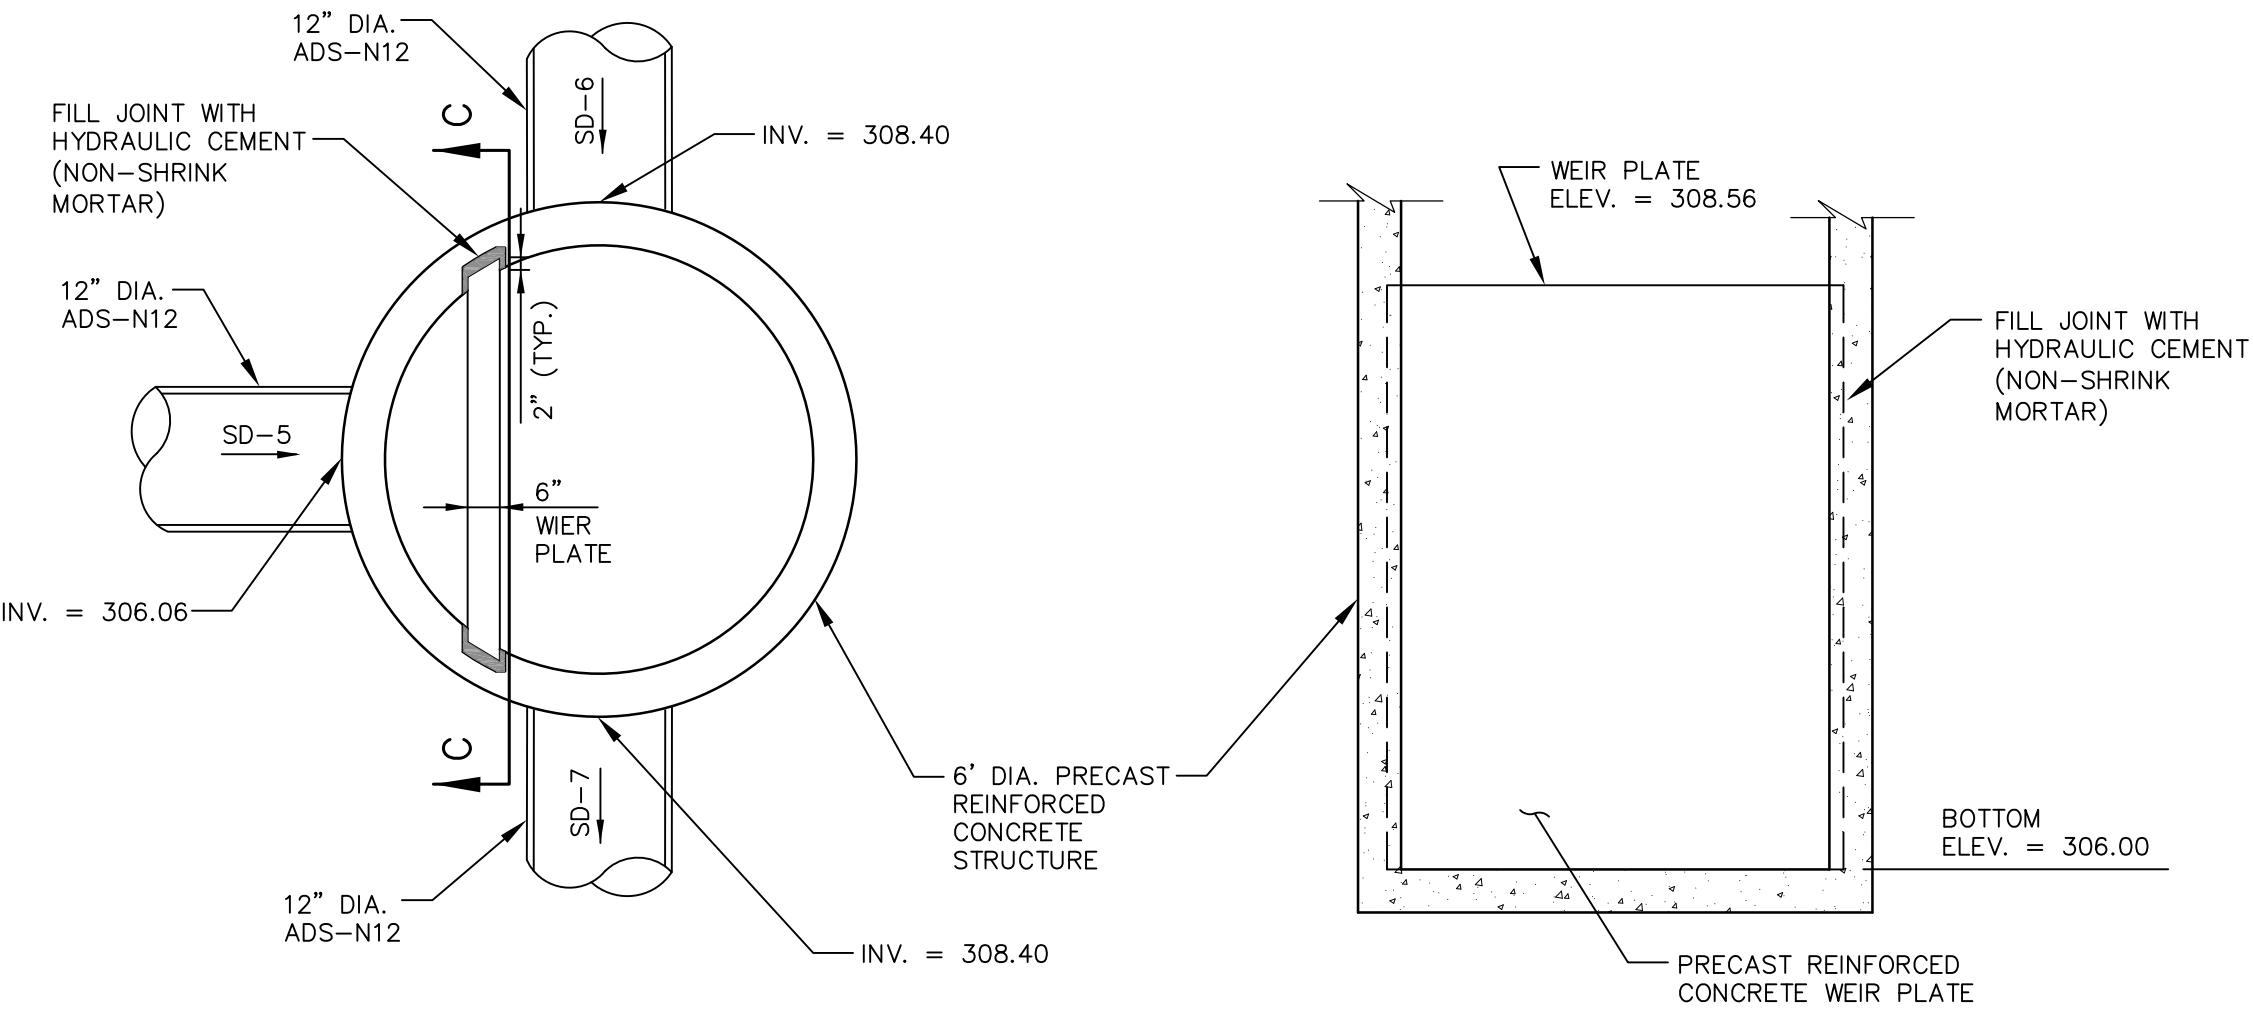


OUTLET CONTROL STRUCTURE OCS-1


NOT TO SCALE

NOTE: STRUCTURE TO BE DESIGNED TO WITHSTAND HS-20 LOADING

SECTION C-C (WEIR PLATE)
NOT TO SCALE

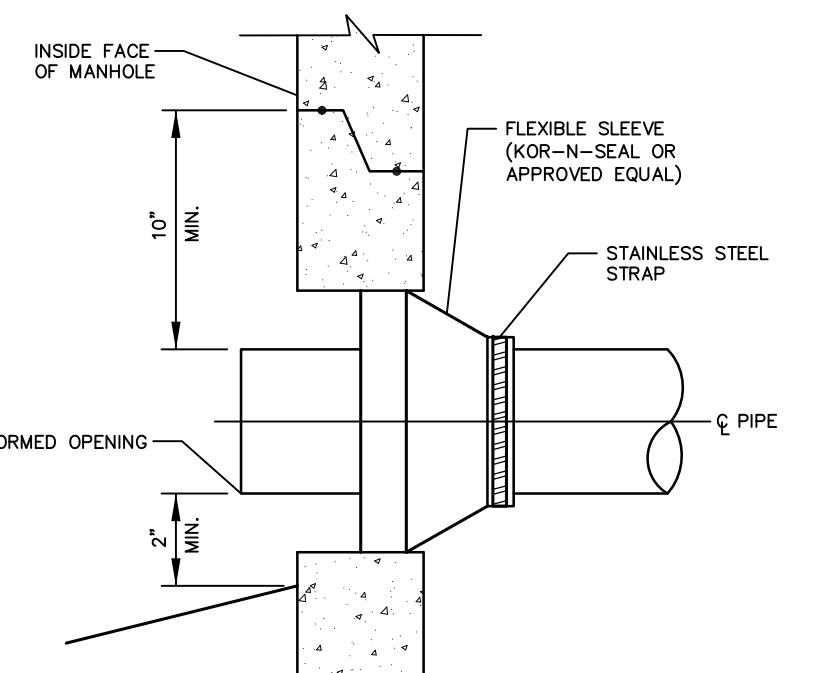


NEW PIPE TO EXISTING MANHOLE
CONNECTION DETAIL - 4" TO 24"
NOT TO SCALE

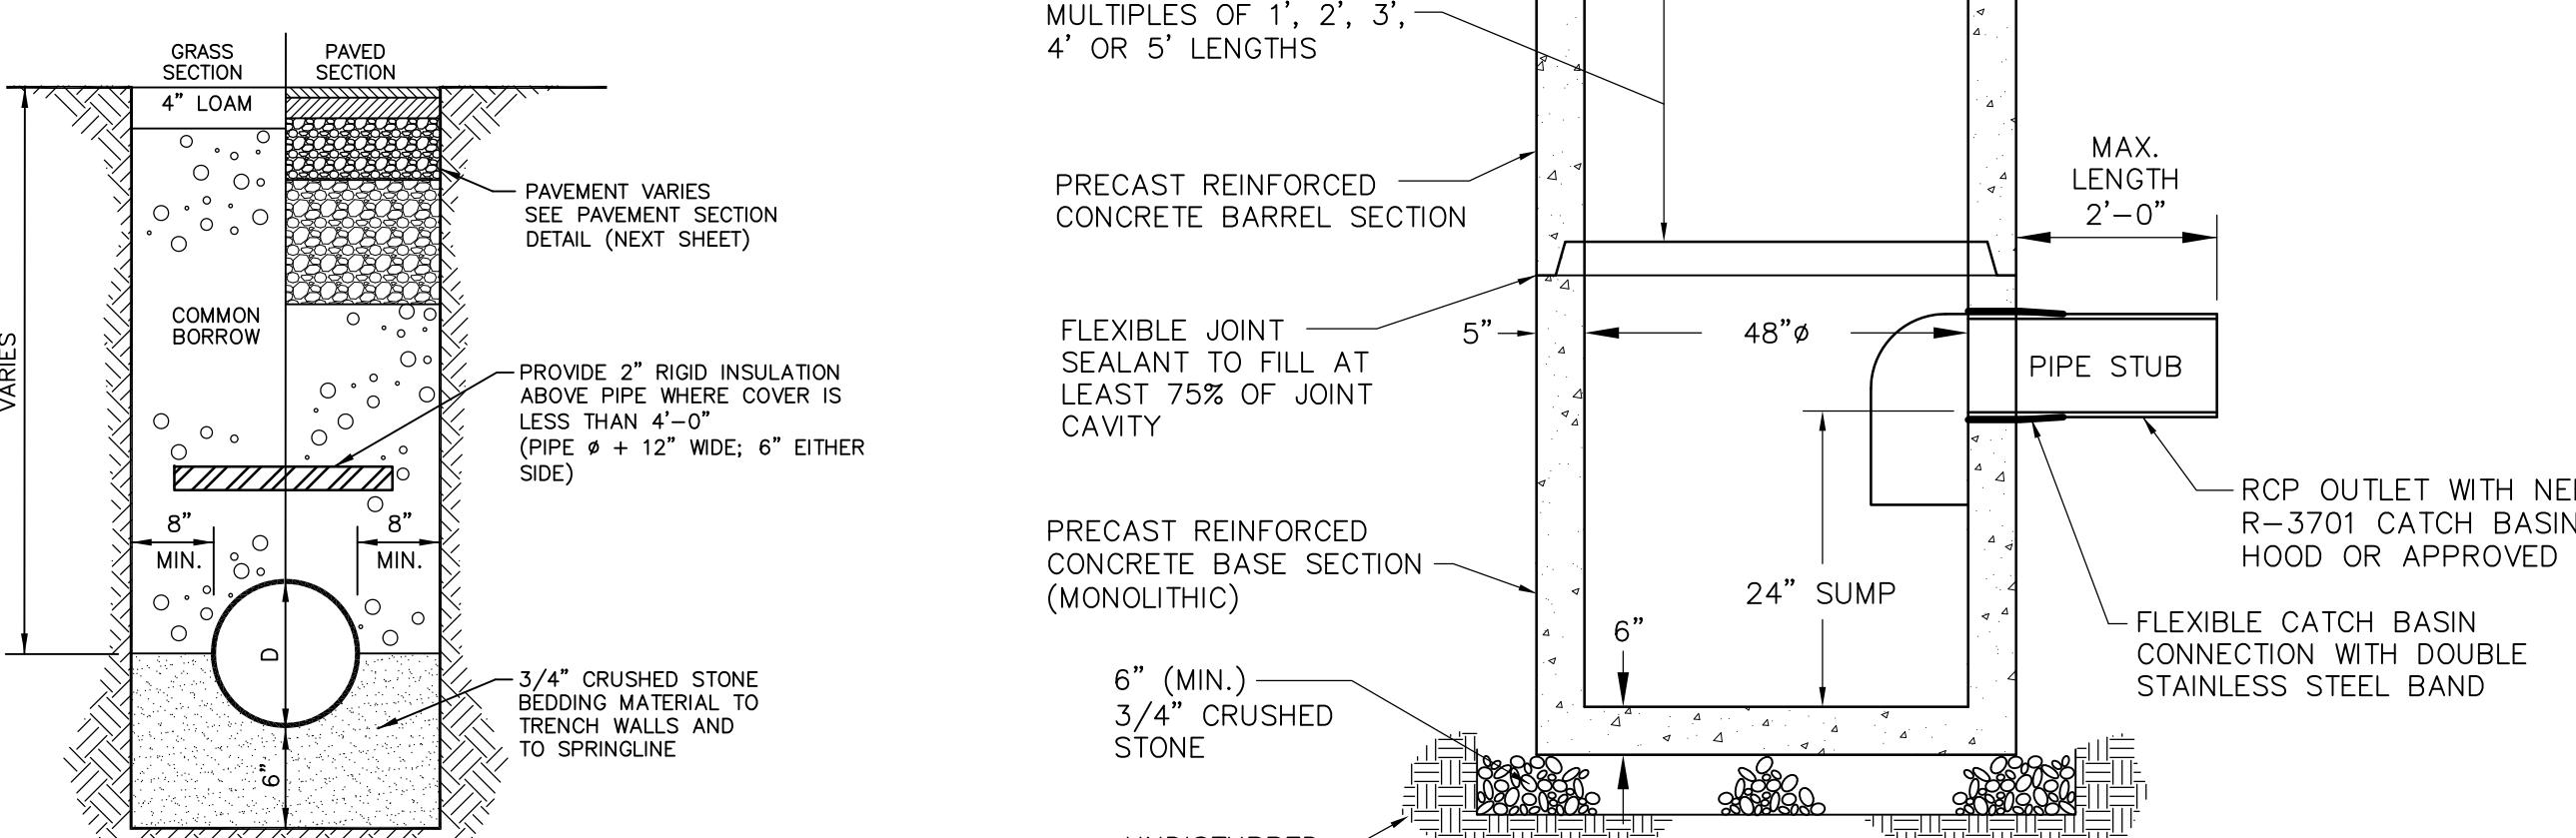


TYPICAL STORM DRAIN
TRENCH SECTION
NOT TO SCALE

PRECAST CONCRETE CATCH BASIN DETAIL
N.T.S.

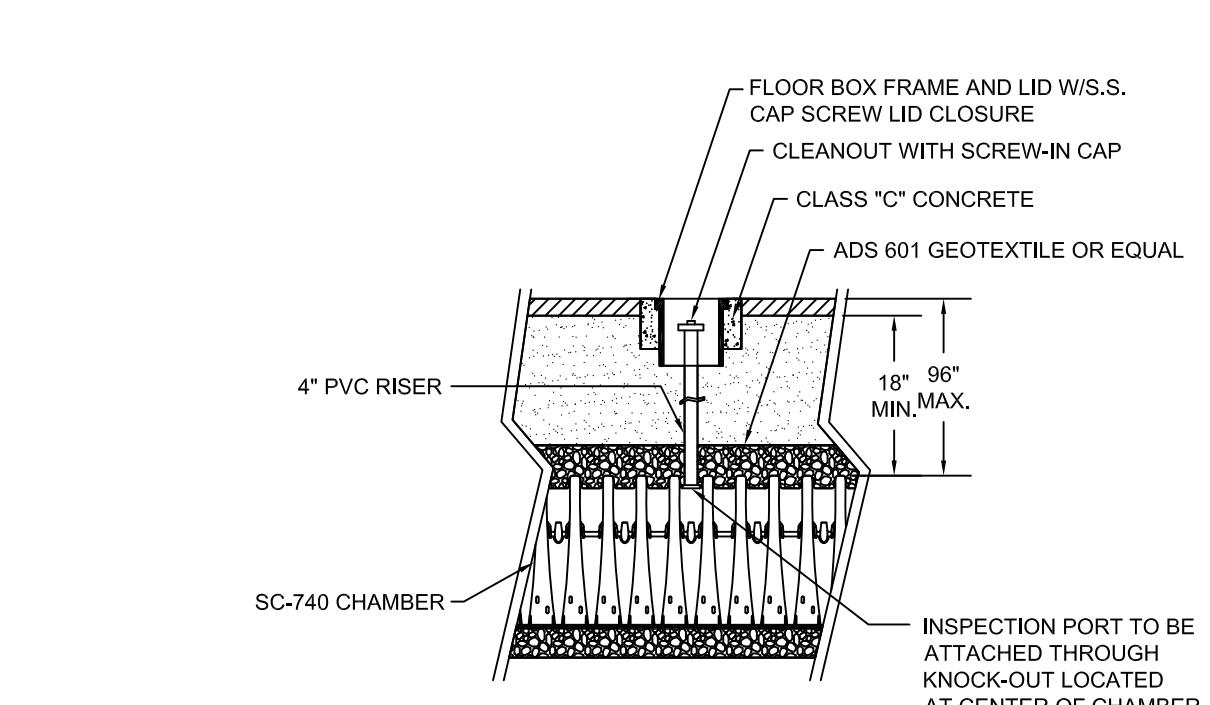


STORMTECH INSPECTION PORT DETAIL


NOT TO SCALE

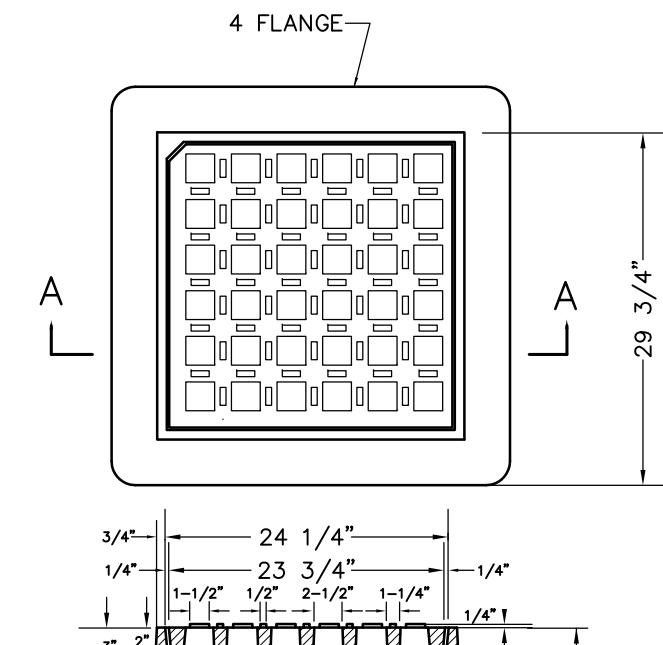

SECTION A-A
CATCH BASIN FRAME AND GRATE
N.T.S.

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Revision:	By:	Date:	Change:
3	SMA	3/16/20	ADDED PROPANE TANKS
2	SMA	1/6/20	REVISED PER TOWN COMMENTS
1	SMA	12/21/20	SUBMITTED FOR TOWN REVIEW
PROJECT NUMBER: 41878 ACAD FILE: 41878-UG-DET.DWG SCALE: AS NOTED DATE: DECEMBER 21, 2020			
Drawing Name: UNDERGROUND DETENTION DETAILS - SHEET 2			
Project Name: FIELDING CONDOS ROOSEVELT TRAIL, WINDHAM, MAINE			
Owner/Applied: FIELDING'S OIL CO., INC.			
 <p>Northeast Civil Solutions INCORPORATED SURVEYING • ENGINEERING • LAND PLANNING 381 PAYNE ROAD, SCARBOROUGH, MAINE 04074 tel 207.883.1000 fax 207.883.1001 e-mail info@northeastcivilsolutions.com website www.northeastcivilsolutions.com</p>			

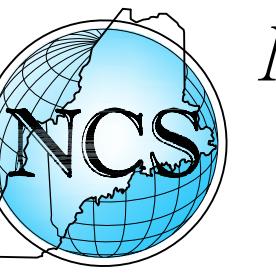

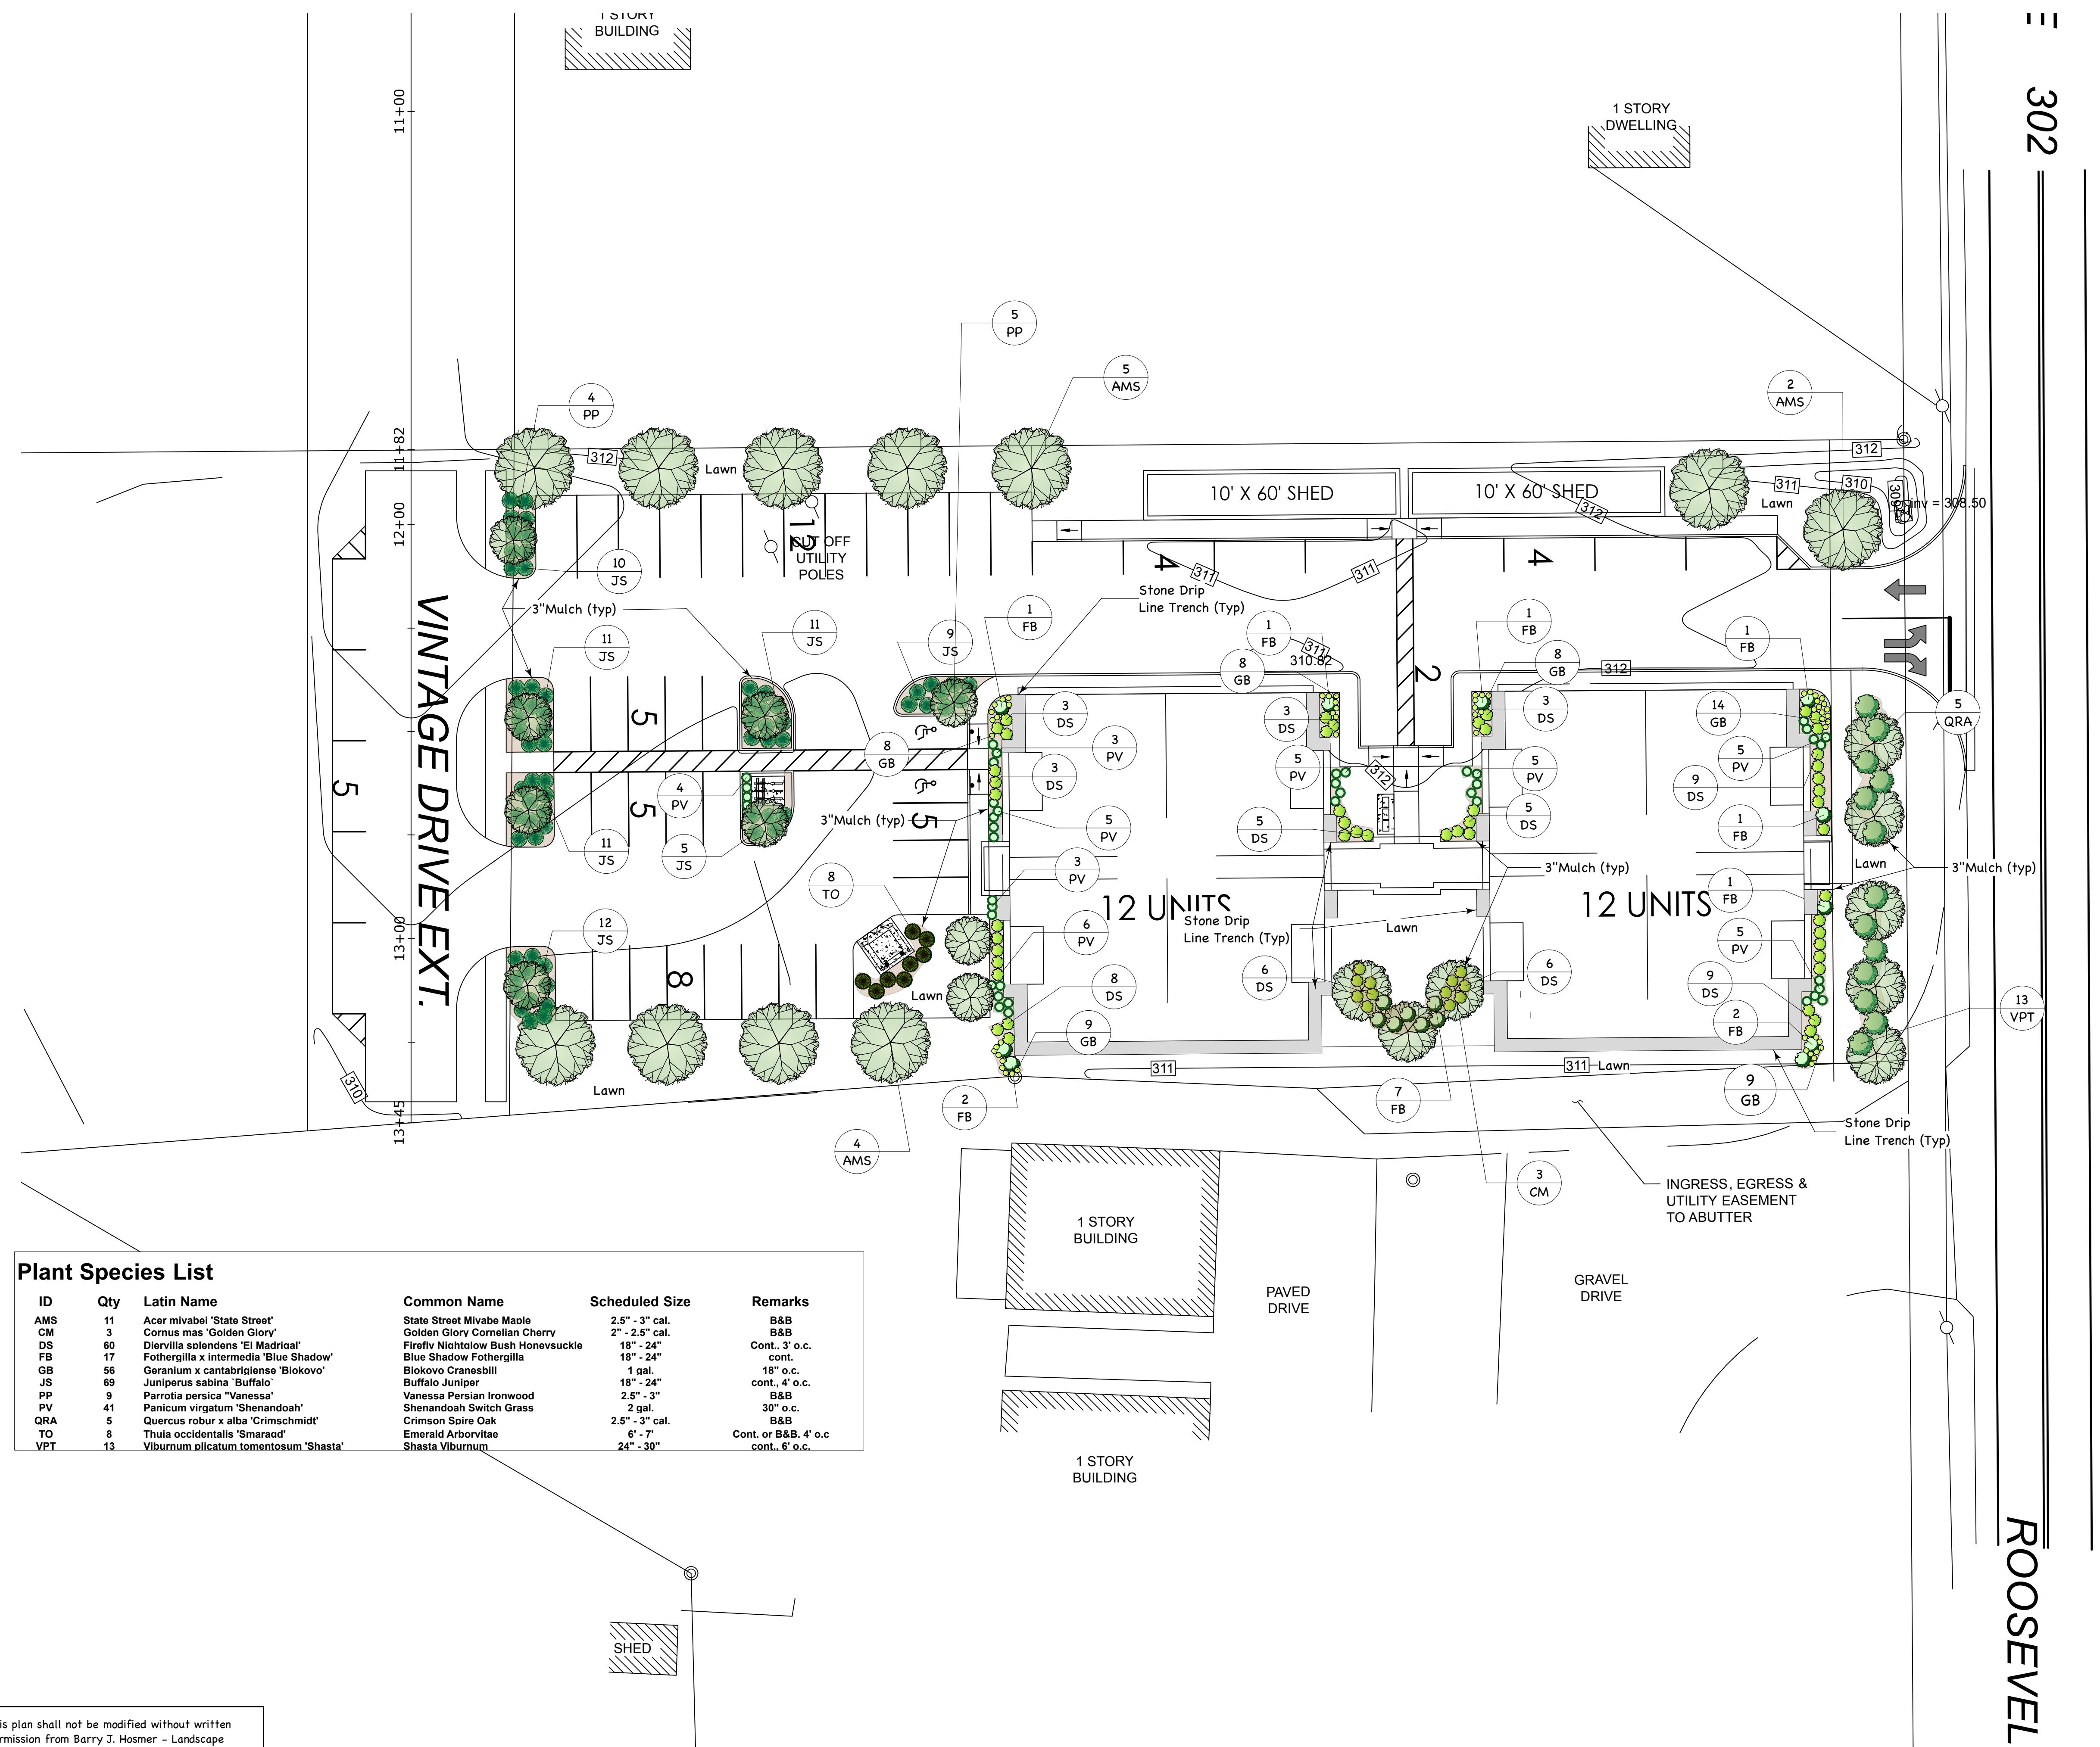
Plant Species List


ID	Qty	Latin Name	Common Name	Scheduled Size	Remarks
AMS	11	Acer mivabel 'State Street'	State Street Mivabe Maple	2.5" - 3" cal.	B&B
CM	3	Cornus mas 'Golden Glory'	Golden Glory Cornelian Cherry	2" - 2.5" cal.	B&B
DS	60	Diervilla solenoides 'El Madrid'	Diervilla solenoides 'El Madrid'	18" - 24"	Cont. 3' o.c.
FB	17	Fothergilla x intermedia 'Blue Shadow'	Firefly Nychitlow Bush Honeysuckle	18" - 24"	cont.
GB	56	Geranium x cantabrigiense 'Biokovo'	Biokovo Cranesbill	1 gal.	18" o.c.
JS	69	Juniperus sabina 'Buffalo'	Buffalo Juniper	18" - 24"	cont. 4' o.c.
PP	9	Parrotia persica 'Virens'	Variegated Ironwood	2.5" - 3"	B&B
PV	41	Parthenocissus quinquefolia 'Shamrock'	Shamrock Virginia Creeper	2" - 3"	30" o.c.
QRA	5	Quercus rubra x alba 'Crimschmidt'	Crimson Spike Oak	2.5" - 3"	B&B
TO	8	Thuja occidentalis 'Smaraud'	Emerald Arborvitae	2' - 7"	Cont. or B&B, 4' o.c.
VPT	13	Viburnum plicatum tomentosum 'Shasta'	Shasta Viburnum	24" - 30"	cont. 5' o.c.

This plan shall not be modified without written permission from Barry J. Hosmer - Landscape Architect. Any alterations, authorized or otherwise, shall be at the user's sole risk and without liability to Barry J. Hosmer - Landscape Architect. File Name: Fielding Oil - Windham v2020.vwx

Plant Notes:

- The Landscape Contractor is advised that these notes and drawing constitute the entire set of construction drawings.
- The Landscape Contractor is advised of the existence of underground utilities. The Landscape Contractor shall verify utilities prior to commencing construction. Call DIGSAFE at 1-888-344-7333.
- The Landscape Contractor shall be responsible for repairing any utilities, walks, paving, curbing, etc. damage in the performance of this job at no cost to the Owner. The Landscape Contractor shall notify the Landscape Architect immediately if any damage occurs under conditions, which will not allow them to carry out the landscape installation according to the drawings.
- Planting of trees shall not occur until all erosion control is in place and all grading and paving is completed. Submit a sample of the topsoil with NPK, pH, calcium, aluminum effective cation exchange capacity tests and fertility recommendations as well as bulk density test of the sample. Topsoil shall be friable void of weeds, stones greater than 3/4" diameter, sticks and other debris. Topsoil shall contain 70-80% sand, 5-20% silt, 5.0-8% organic matter and a pH of 6-6.9. Notify the Landscape Architect immediately if there is standing water or other factors, which would prohibit the installation of plant material.
- All plants shall have a normal habit of growth for the species and shall be sound, healthy and free of diseases and insects. All plants shall be legibly tagged with the proper completed botanical name. They shall conform to the minimum size of 18" height and 2" diameter at the 6" height. Prior to plant installation, the Landscape Contractor shall submit a written affidavit of all plant species, cultivars, varieties, sizes and quantities that they propose to install with the name, phone number and location of all nurseries where plant material has been grown. All plants shall be grown in a latitude north of Washington. The Landscape Architect will inspect all plants at the place of growth or upon delivery for conformity to the plant list and specifications. Such approval shall not affect the right of inspection and rejection during the progress of work. The Landscape Architect and Owner reserve the right to inspect, select and cut all plants material that are planted or grown in selected and approved a representative sample of each type of plant, bare groundcover or annual. The samples selected will serve as a minimum standard for plants of the same species used for this work.
- The top 1/3 of wire baskets and burlap on trees shall be cut and removed. All other plant material including trees shall have all non-biodegradable materials (string, wire, pots, etc.) removed at the time of planting. Circles on plants which would later girdle the plant shall be straightened, cut or the root ball shall be cut using a split ball technique.
- Backfill mix shall be composed of 80/20 top soil/ peat moss mix. Planting pits shall be excavated to three times the diameter and to the same depth of the plant root ball. Backfill 1/2 of the pit at a time, and compact. See Note 8 and install slow release fertilizer after first backfill lift. Setting the tree/shrub: Each tree/shrub shall be planted so that the trunk flare junction is level with or 1" above existing grade. All trees/shrubs shall be planted to the same depth as the root ball. The landscape contractor shall be responsible for the placement of the tree/stake.
- All plantings shall have slow release fertilizer installed at the time of planting. The fertilizer shall be "Roots Transplant 1 Step", installed/ applied according to manufacturers instructions according to manufacturers instructions. After the plants installed in each area, liquid feed all plants with Roots - Liquid Concentrate. Mix and apply according to manufacturers instructions. The landscape contractor shall be responsible for the placement of the fertilizer in each area prior to plant installation. The Landscape Contractor shall not install any plant material unless appropriate watering equipment is on site. All plants shall be adequately watered the day of installation or these plants will be rejected and replaced by the Landscape Contractors at no cost to the owner.
- All trees shall have 2 stakes and guys. Stakes shall be 2" x 2" hardwood of sufficient length to guy above the first branches. Guys shall be flexible guying chord or approved equal. Submit a sample of guying prior to installation. Any guys with a diameter of 1/2" or greater shall be removed by the landscape contractor to remove all stakes after 1 year. All trees shall have treeguards installed at the time of planting and shall be fill one a week from April thru November. Treeguards shall be either the 'Original' or 'Tregator Jr.'
- Mulch to be installed to a depth of 3' after normal settling including the seasonal color areas. Mulch shall be medium shredded Hemlock bark, dark brown in color. Do not place mulch in contact with the tree trunk. The Landscape Contractor shall submit a 25 cubic foot sample prior to installation.
- All plantings shall be spaced according to the plan and as noted in the Plant Species List. All plants shall be oriented for best appearance and arranged to evenly occupy the space where they are planted.
- Plant species and plant size substitutions will not be allowed unless first approved by the Landscape Architect.
- All plants shall be planted without prior approval will be rejected.
- All plants shall be planted for a period of one year and shall be replaced at no cost to the owner if any plants die during the guarantee.
- Allow deciduous and evergreen shrubs to grow together to form a continuous plant mass.
- The contractor shall supply the quantities of plants sufficient to complete the work shown on all of the drawings. If quantities of plants listed in the plant species list do not correlate with the plantings indicated on the drawings, quantities on the drawings shall govern. Any discrepancies between the plant list and the drawings shall be handled by the landscape contractor to additional remuneration. Notify the Landscape Architect immediately if discrepancies are detected.
- Under no circumstance shall snow be plowed and piled on planting areas. This will result in crushing and death of the plant material and void the one year warranty.

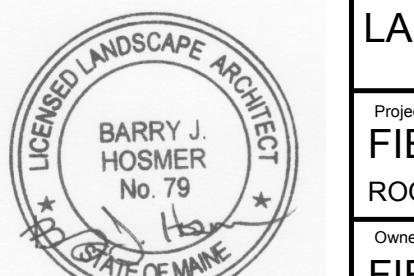Revision:	By:	Date:	Change:
PROJECT NUMBER: ACAD FILE: SCALE: 1" = 30' DATE:			
Drawing Name: LANDSCAPE PLAN			
Project Name: FIELDING CONDOS ROOSEVELT TRAIL, WINDHAM, MAINE			
Owner/Applicant: FIELDING'S OIL CO., INC.			
 Barry J. Hosmer ASLA Landscape Architecture Land Planning 196 Whitney Avenue Portland, Maine 04102 207-874-0248			
SHEET 1 OF 1			

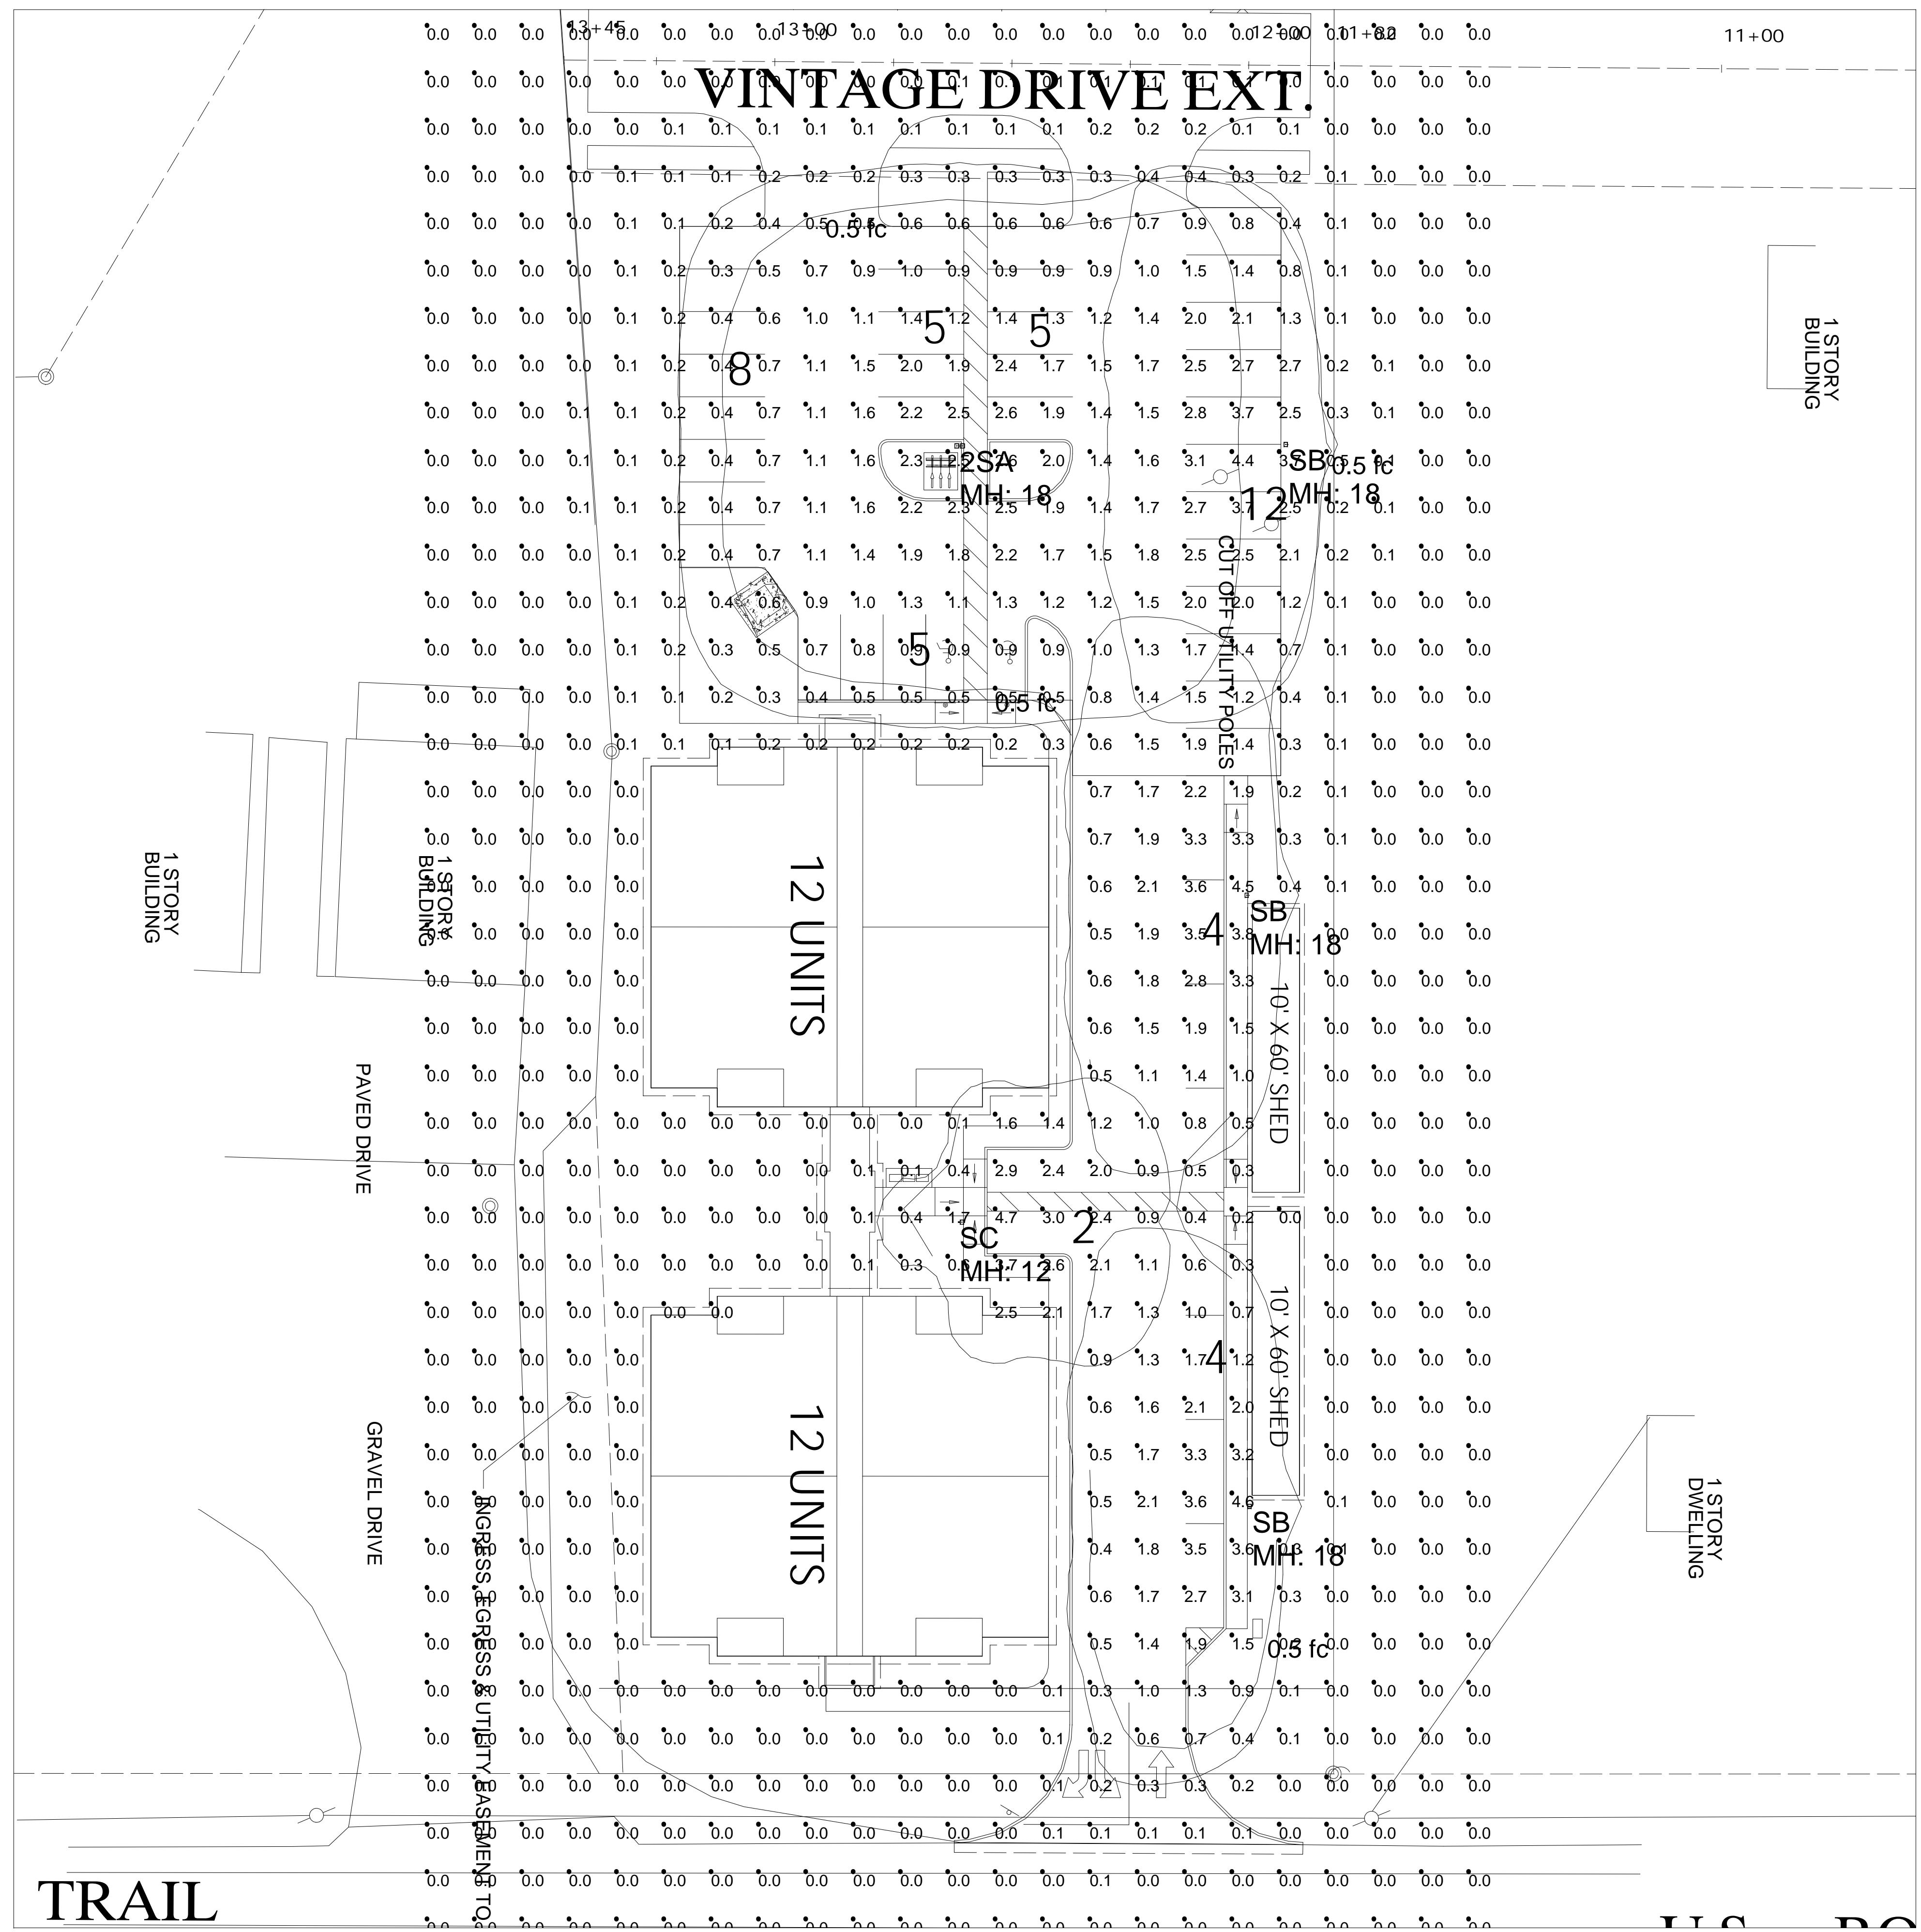

NOTES:

- 1) EXACT MOUNTING DETAILS TO BE DETERMINED AT JOBSITE BY OTHERS.
- 2) CALCULATIONS MAY or MAY NOT SHOW THE EFFECT OF SHADOWING CAUSED BY BUILDINGS AND OBJECTS WITHIN THE CALCULATED SPACE OR IN THE SITE AREA.
- 3) READINGS SHOWN ARE INITIAL HORIZONTAL FOOTCANDLES ON A FLAT SITE WITHOUT REFLECTIONS OR OBSTRUCTIONS UNLESS OTHERWISE INDICATED.
- 4) THIS CALCULATION IS BASED ON LIMITED INFORMATION SUPPLIED BY OTHERS TO SWANEY LIGHTING ASSOCIATES AND STANDARD ASSUMPTIONS OF THE SPACE AND/OR SITE.
- 5) CONFORMANCE TO CODES AND OTHER LOCAL REQUIREMENTS AS DETERMINED BY THE AHJ ARE THE RESPONSIBILITY OF THE OWNER AND/OR THE OWNER'S REPRESENTATIVE.
- 6) THIS LAYOUT DRAWING MUST BE COORDINATED WITH THE SITE LOCATION FOR CORRECT FIXTURE ORIENTATION.
- 7) DOCUMENTS PRINTED OR PLOTTED FROM ELECTRONIC FILES MAY APPEAR AT OTHER THAN THE DESIRED OR ASSUMED GRAPHIC SCALES. IT IS THE RESPONSIBILITY OF THE RECIPIENT TO VERIFY THAT THE PRINTED OR PLOTTED-TO-SCALE DRAWING IS PRINTED TO SCALE.

Calculation Summary					
Label	Avg	Max	Min	Avg/Min	Max/Min
SITE	0.44	4.7	0.0	N.A.	N.A.
PARKING	1.45	4.4	0.3	4.83	14.67

Luminaire Schedule (note fixture catalogue numbers are not complete)					
Type	Qty	Lum. Lumens	LLF	Lum. Watts	Description
2SA	1	7908	0.900	80.52	TWIN VP-S-36L-80-3K7-4W
SB	3	7516	0.900	109.78	VP-S-48L-110-3K7-3-BC
SC	1	5400	0.900	54	VP-S-24L-55-3K7-4

NOTICE: THIS DRAWING IS THE EXCLUSIVE PROPERTY OF SWANEY LIGHTING ASSOCIATES. ITS ACCEPTANCE CONSTITUTES AN AGREEMENT THAT THE DRAWING WILL BE TREATED AS CONFIDENTIAL. THIS DRAWING IS TO BE USED FOR NO PURPOSE OTHER THAN AS DETAILED IN INFORMATION CONCERNING THE OPERATION OF UNITS INDICATED. THIS DRAWING IS TO BE RETURNED UPON REQUEST AND IS NOT TO BE COMMUNICATED, DISCLOSED OR COPIED; EXCEPT AS EXPRESSLY AUTHORIZED BY SWANEY LIGHTING ASSOCIATES.

NOTICE: THE INTENT OF THIS LIGHTING LAYOUT IS TO SUGGEST THE BEST UTILIZATION OF LIGHTING FIXTURES INCLUDED IN THIS DRAWING. IT IS PROVIDED USING FIXTURE PHOTOMETRICS FURNISHED BY THE MANUFACTURER. ANY VARIATION IN FIXTURE PERFORMANCE FROM PERFORMANCE SHOWN INIES FILE IS NOT THE RESPONSIBILITY OF THE MANUFACTURER. IT'S USE FOR ANY OTHER PURPOSE IS NOT AUTHORIZED BY SWANEY LIGHTING ASSOCIATES.



Perspective (not to scale)

SHEET NOTES



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GENERAL SHEET NOTES

1. PLAN

GRAPHIC LEGEND


 - New Wall



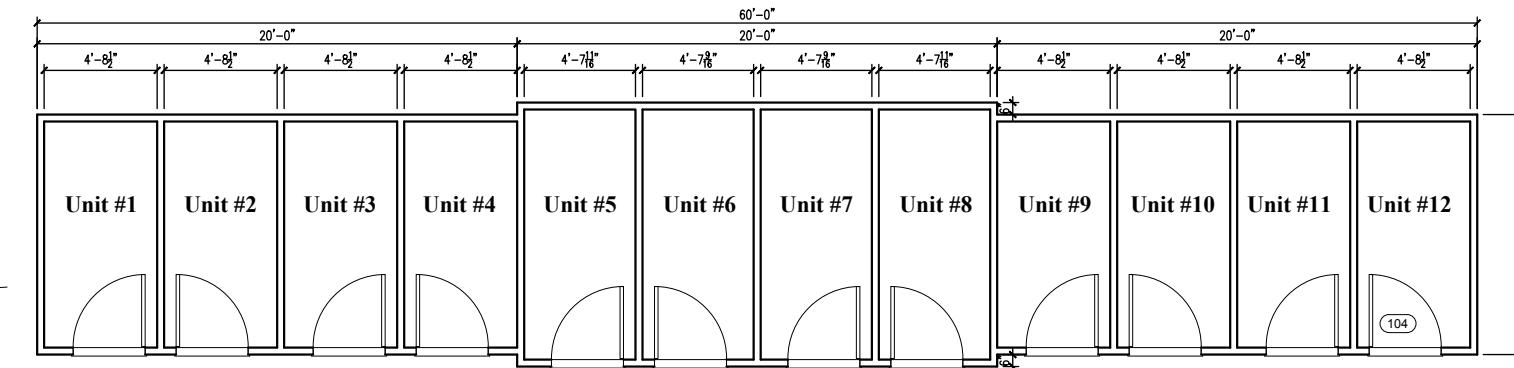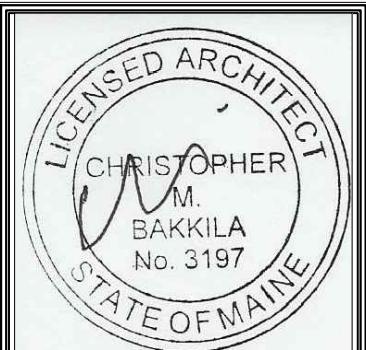


Storage Floor Plan


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UNIT B

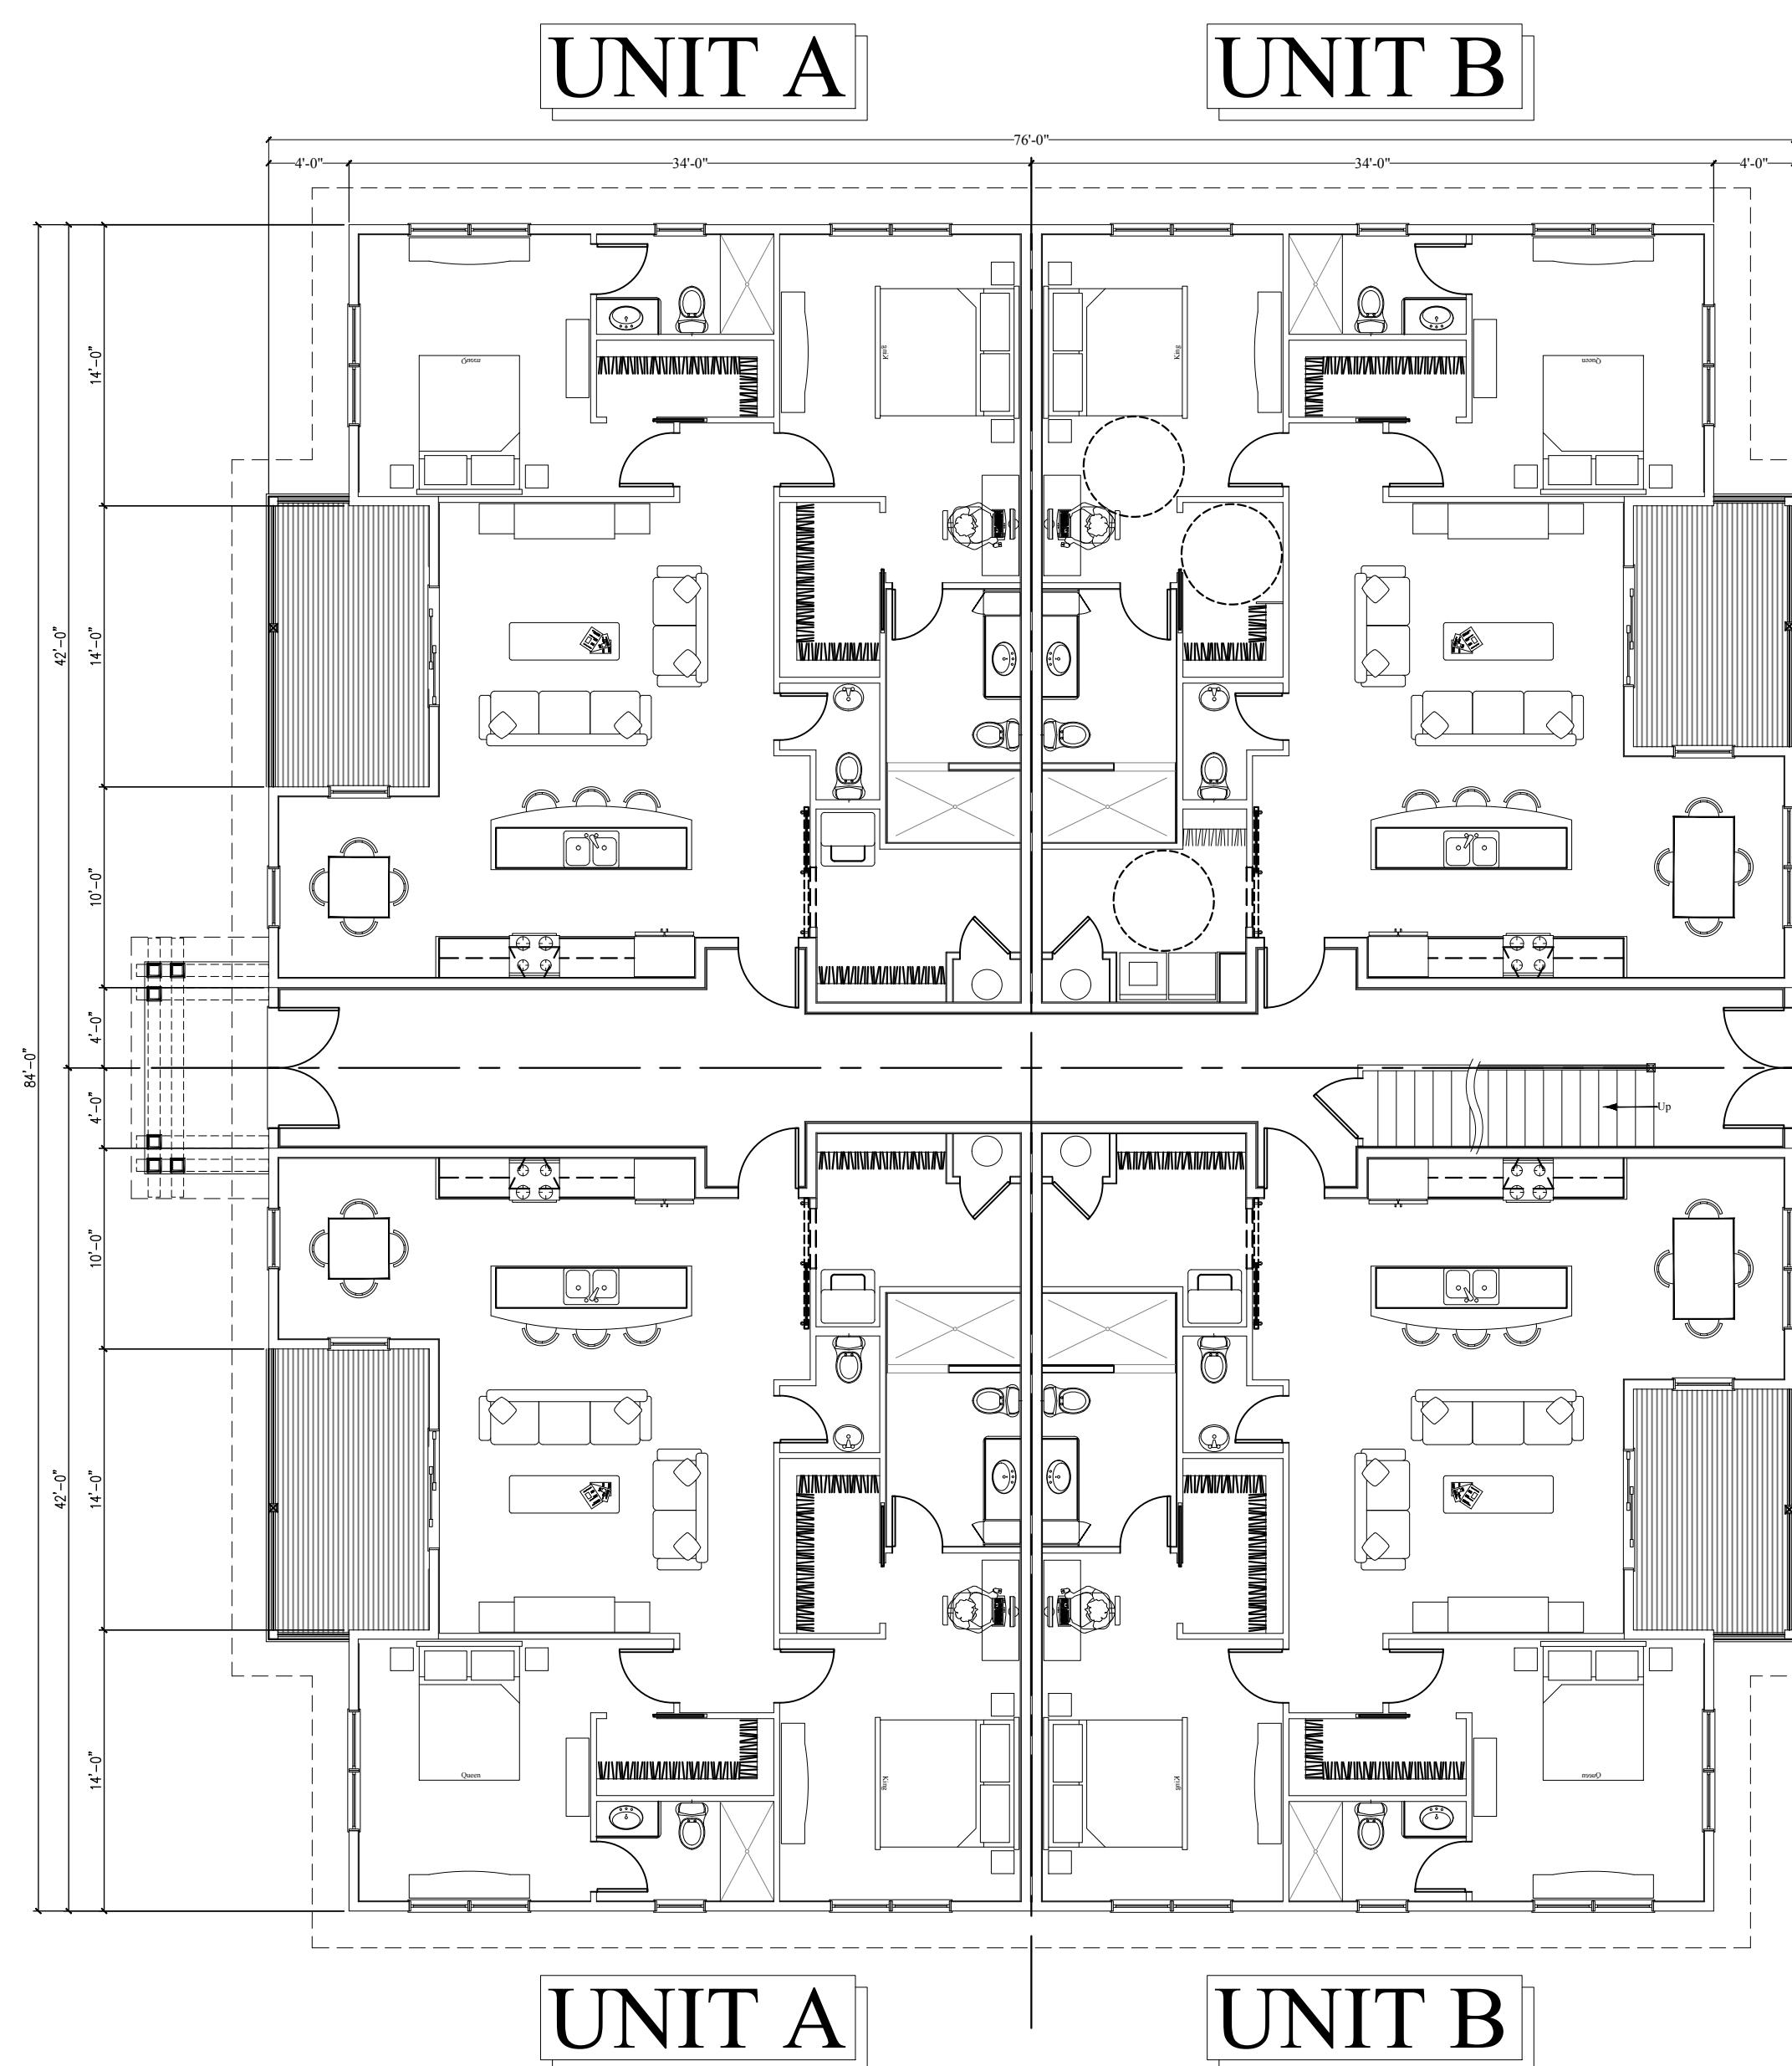

First Floor Plan

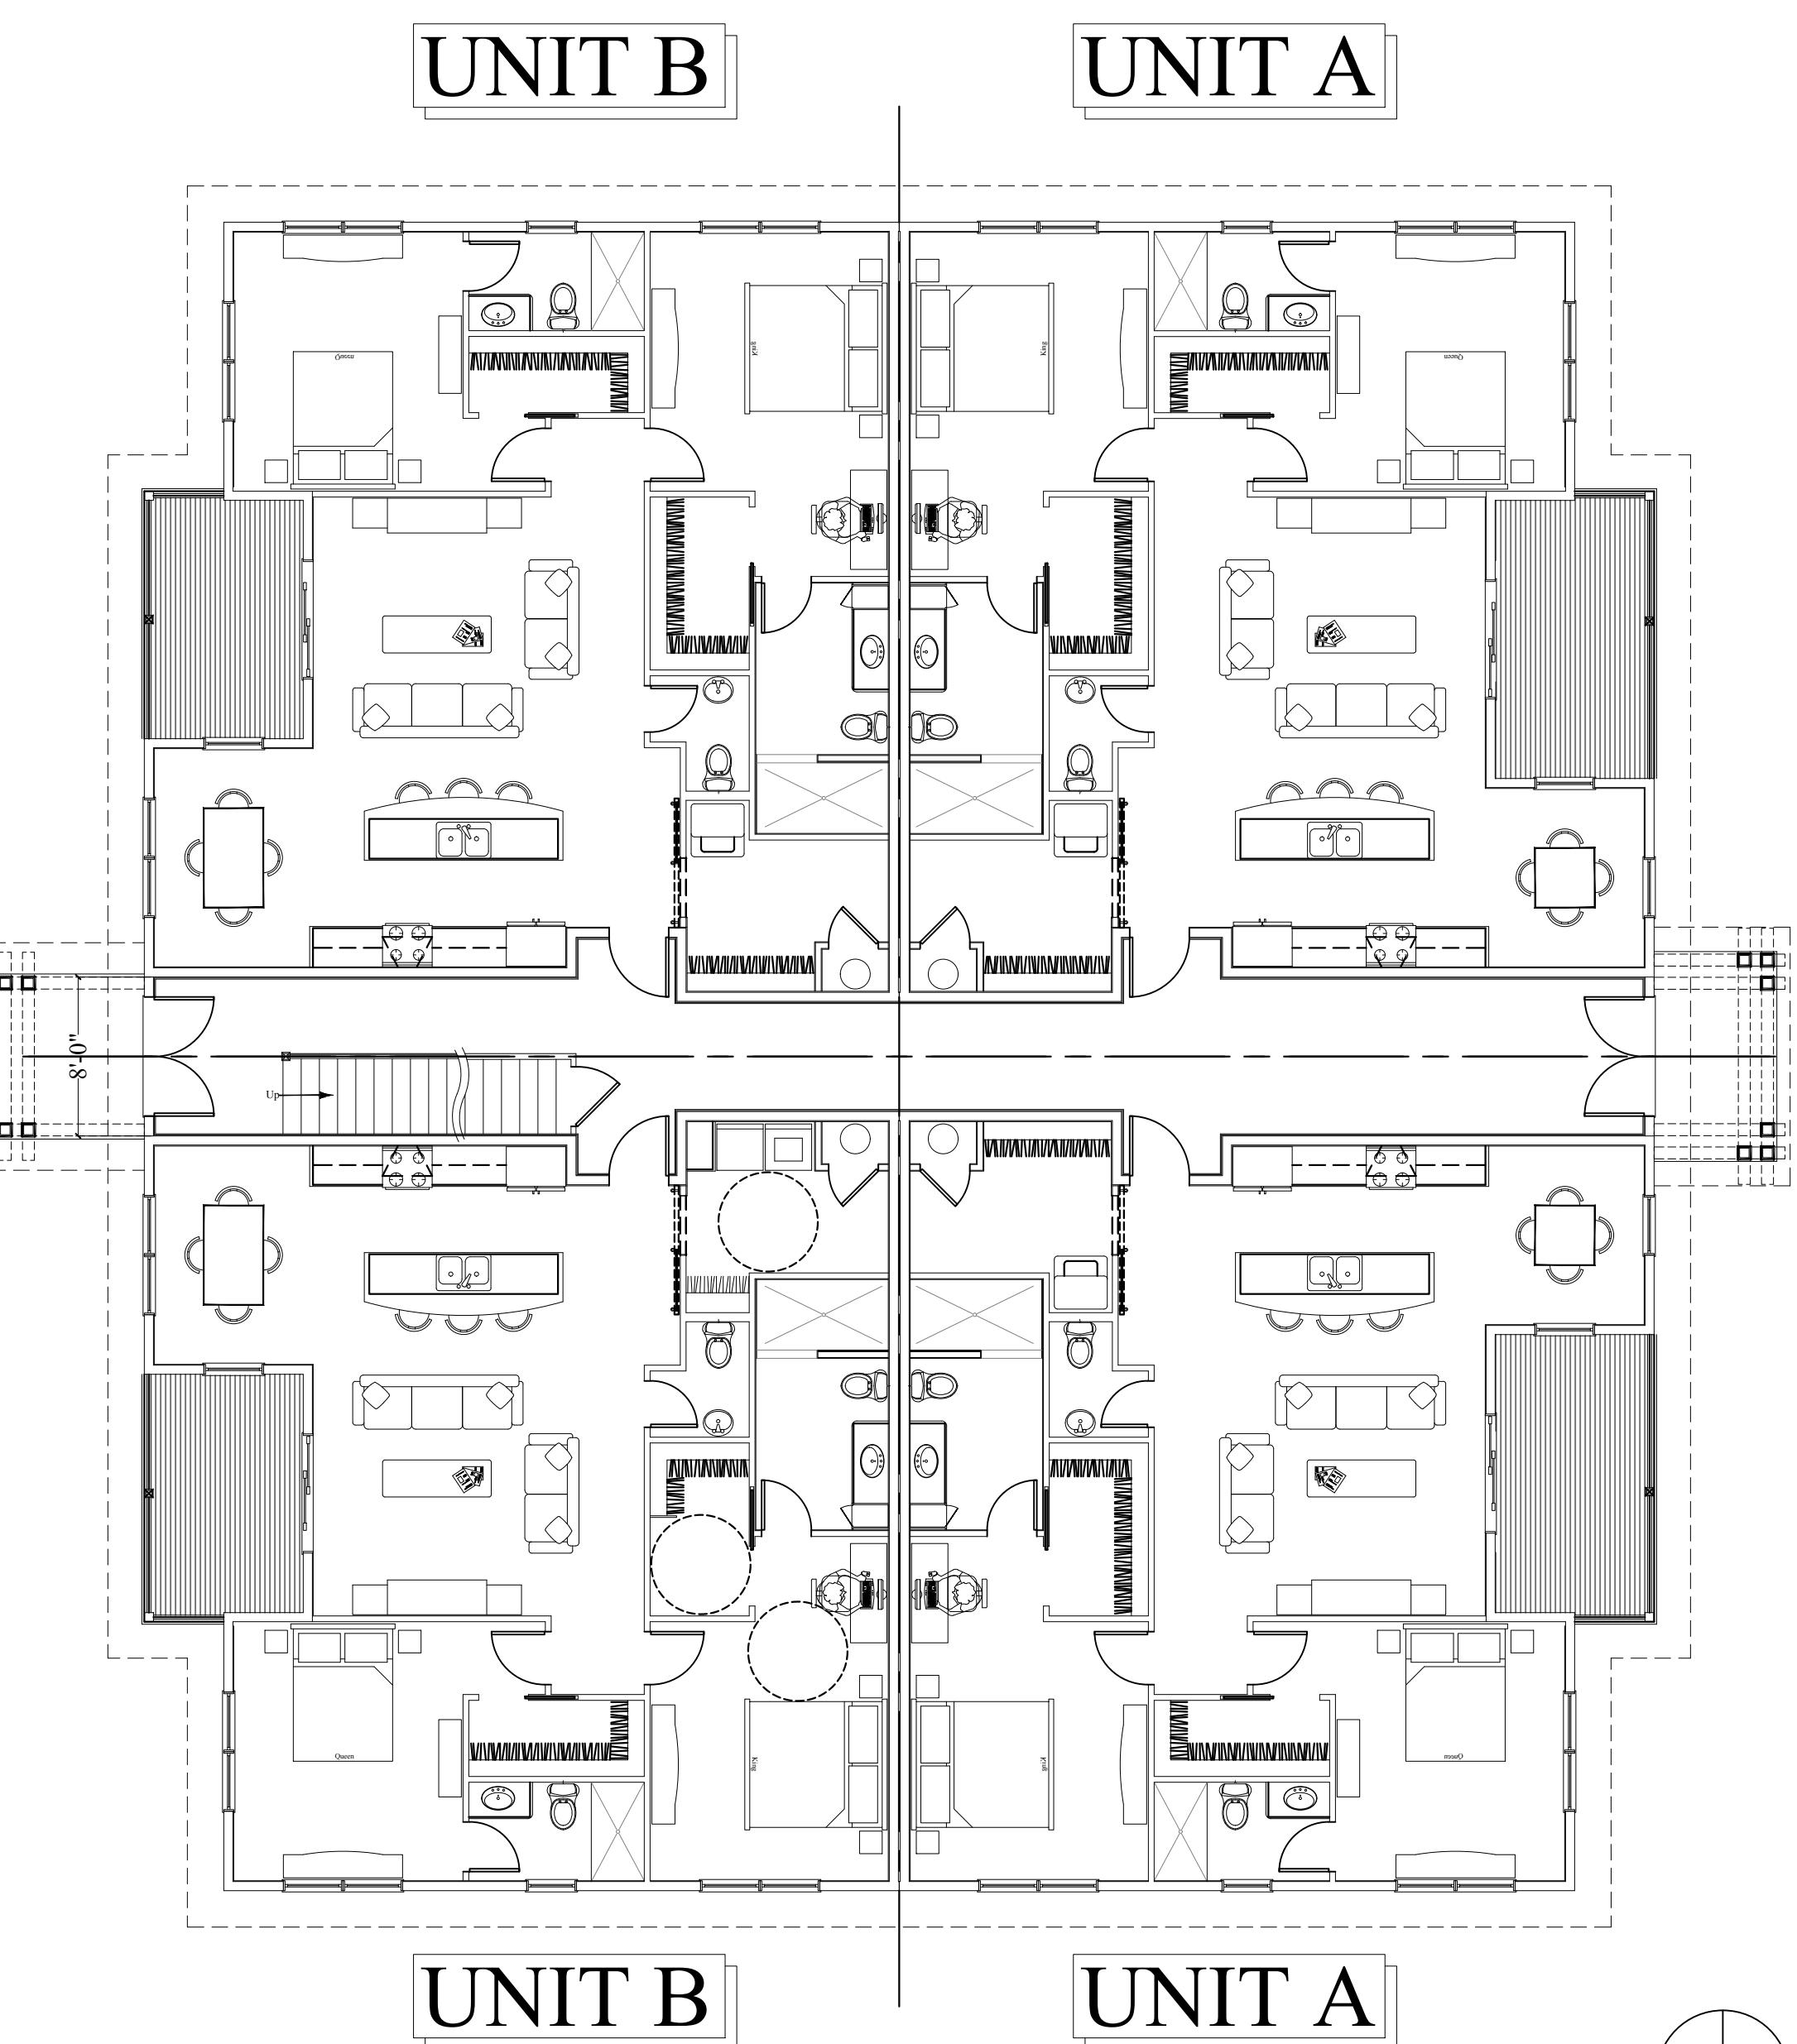


TE:
ARCH 09, 2021

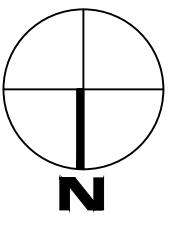A1.1

	
DESCRIPTION	
DATE	
NO.	
REVISIONS	

H T E C T U R E		W I T E 1 a - S C A R B O R O U G H , M A I N E 0 4 0 7 4		8 3 W W W . C U S T O M C O N C E P T S I N C . C O M	
JOB NUMBER: 2020-17		<input checked="" type="checkbox"/> Preliminary Design <input type="checkbox"/> Development <input type="checkbox"/> Design <input type="checkbox"/> Contract Documents		CLIENT REVIEW ONLY - NOT CONSTRUCTION FOR PERMITS, BIDS, AND CONSTRUCTION	
DRAWN BY: CMB					
SCALE: 1/8" = 1'-0"					

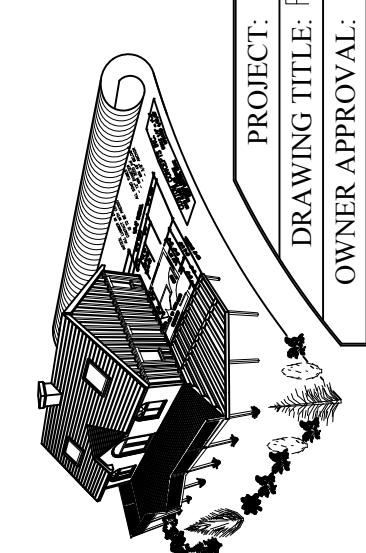

DATE:
MARCH 09, 2021